



POTRERO GATEWAY

PUBLIC ARTWORK SAN FRANCISCO, CA 94103

PROJECT NOTES

- 1. Where the terms "approval equal", "equal to," or other general qualifying terms are used in these notes, it shall be understood that reference is made to the ruling and judgment of the Lead
- 2. The general contractor shall verify all dimensions and job conditions and shall report to the Lead Artist and Structural Engineer any discrepancies or omissions which would interfere with satisfactory completion of the project.
- 3. Unless otherwise noted, all dimensions shown are from centerline to centerline, centerline to face of the wall, or face of wall to face of wall.
- 4. Electrical, mechanical, plumbing, and structural drawings are supplementary to the Lead Artist drawings. Mechanical and electrical fixtures, fittings, outlets, etc. when shown on the Lead Artist drawings are for location information only.
- 5. It shall be the responsibility of each contractor to check with the Lead Artist drawings before the installation of their work. Any discrepancy between the Lead Artist and consulting engineer's drawings shall be brought to Lead Artist's attention.
- 6. Any work installed in conflict with the Lead Artist drawing shall be corrected by the contractor at his expense and no expense to the owner.
- 7. The construction notes and/ or drawings are supplied to illustrate the design and general type of construction desired and are intended to imply the finest quality of construction, material and workmanship throughout. All errors, omissions, and clarifications must be brought to the attention of the Lead Artist and Structural Engineer.
- 8. The general contractor shall maintain a current and complete set of construction drawings on site during all phases of construction for the use of trades.
- 9. The general contractor shall notify the Lead Artist and Structural Engineer of any discrepancies between the drawings, these notes, and field conditions before commencing any work and request clarification.
- 10. The location of the utilities shown on these plans are based on field observation and/or record drawings. The information shown is not necessarily complete and the location of the utilities shown in approximate. The contractor will verify the existence of all utilities in advance of conducting construction operations that could damage these utilities.
- 11. In the areas where proposed construction may conflict with existing utilities, the contractor will take all necessary precautions to avoid damage to the utilities.
- 12. Stated amounts are indicative and may be approximate, and not exact amount. Determining amounts is the responsibility of the contractor.
- 13. In the technical description are generally known products. The contractor must take account of auxiliary equipment, finishes and neat connections.
- 14. The contractor must provide samples of all image-defining materials.
- 15. All steel structure that comes into view is to be held to high aesthetic requirements. All carbon steel structure that comes into view is to be galvanized and painted.
- 16. All wiring and installation should be in accordance with National Electric Code (NEC) and
- 17. The illustrated project was designed to comply with all requirements of the Americans with Disability Act ("ADA") and other Federal, State and Local guidelines including but not limited to the Public Rights of Way Accessibility Guidelines ("PROWAG"). If the project is located in the state of California, the California Building Code (CBC).
- 18. Contractors should be aware that published values for dimension and slope are for finished construction, no tolerance is permitted below minimum or above maximum values. Contractors must set tolerances to ensure constructions which comply with regulations. If contractors observe designs or site conditions that will not comply with the aforementioned rules and regulations it is their responsibility to notify the owner and designer immediately.
- 19. FUTUREFORMS® retains all rights in the design(s) under the Copyright Act of 1976, 17 U.S.C. §101 et seq., as the sole author of the Artwork for the duration of the copyright. FUTUREFORMS sketches, concepts, schematic designs, technical and fabrication details remain the sole property of FUTUREFORMS, and can only be executed in final form by FUTUREFORMS. Any use of material included herein should clearly credit FUTUREFORMS.

SYMBOL LEGEND




NORTH ARROW



ELEVATION

DETAIL CALL OUT

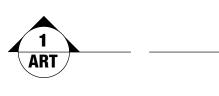

OR SECTIONAL CALL OUT



CENTER LINE



REVISION SYMBOL

ELEVATION TARGET

PROJECT INFORMATION

DESCRIPTION:

FABRICATION AND INSTALLATION OF PUBLIC ART CONSISTING OF (4) INDIVIDUAL STEEL SCULPTURES.

PROJECT CONTACTS:

San Francisco Arts Commission (SFAC) Aleta Lee, M.A. Project Manager, Public Art Program email: aleta.lee@sfgov.org

San Francisco Department of Public Works (SFDPW) Trent Tieger, PE, PMP

Project Manager

e-mail: trent.tieger@sfdpw.org

Community Contacts: Potrero Gateway Park Steering Committee (Jean Bogiages, Michael Kerbow, Sheldon Trimble)

Maintenance:

Green Benefits District (Julie Christensen)

Installation Team: Atthowe Fine Arts Services

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ARTWORK

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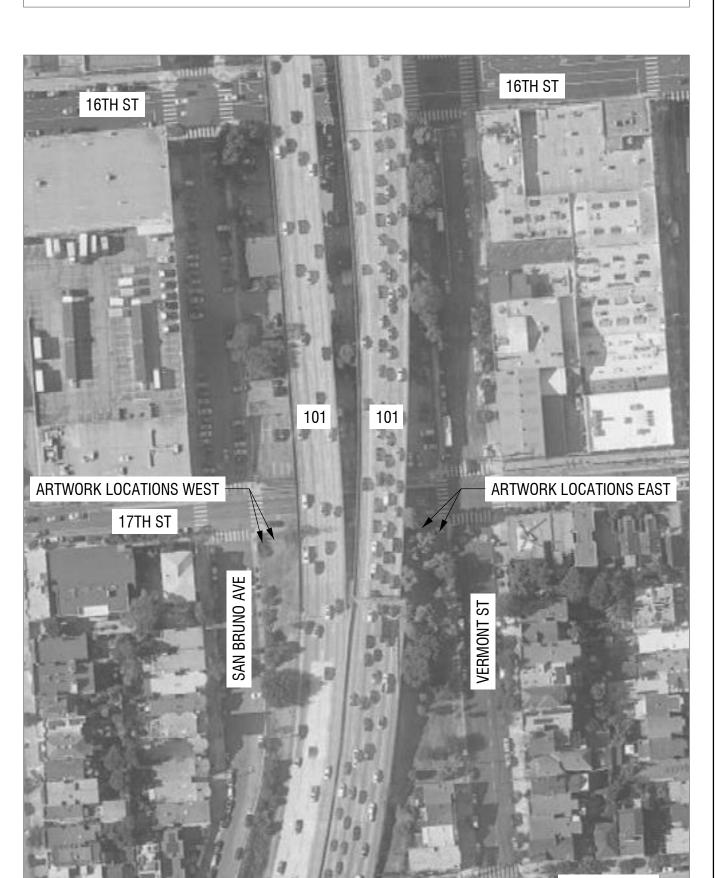
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STRUCTURAL

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S-3 ENLARGED ARTWORK PLAN

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VICINITY MAP

REVISIONS

ARTIST:

FUTUREFORMS

2325 3RD STREET, SUITE 229, SAN FRANCISCO, CA 94107

JASON KELLY JOHNSON

jason@futureforms.us

STRUCTURAL ENGINEER:

STRUCTURAL ENGINEERS, INC.

TUAN and ROBINSON

(415) 957-2480

444 SPEAR ST, STE 101

SAN FRANCISCO, CA 94105

(415) 255-4879

6/10/22 - CD SET 7/20/22 - CD SET REVISED TO REMOVE HIGHLY REFLECTIVE FINISHES FROM ARTWORKS

PROJECT NAME POTRERO GATEWAY


17th ST, BTW VERMONT ST AND SAN BRUNO AVE SAN FRANCISCO, CA 94103


SHEET TITLE

PROJECT INFORMATION

DRAWING SCALE AS NOTED ON DRAWINGS SHEET SIZE: 24 x 36

DATE ISSUED 7/20/22

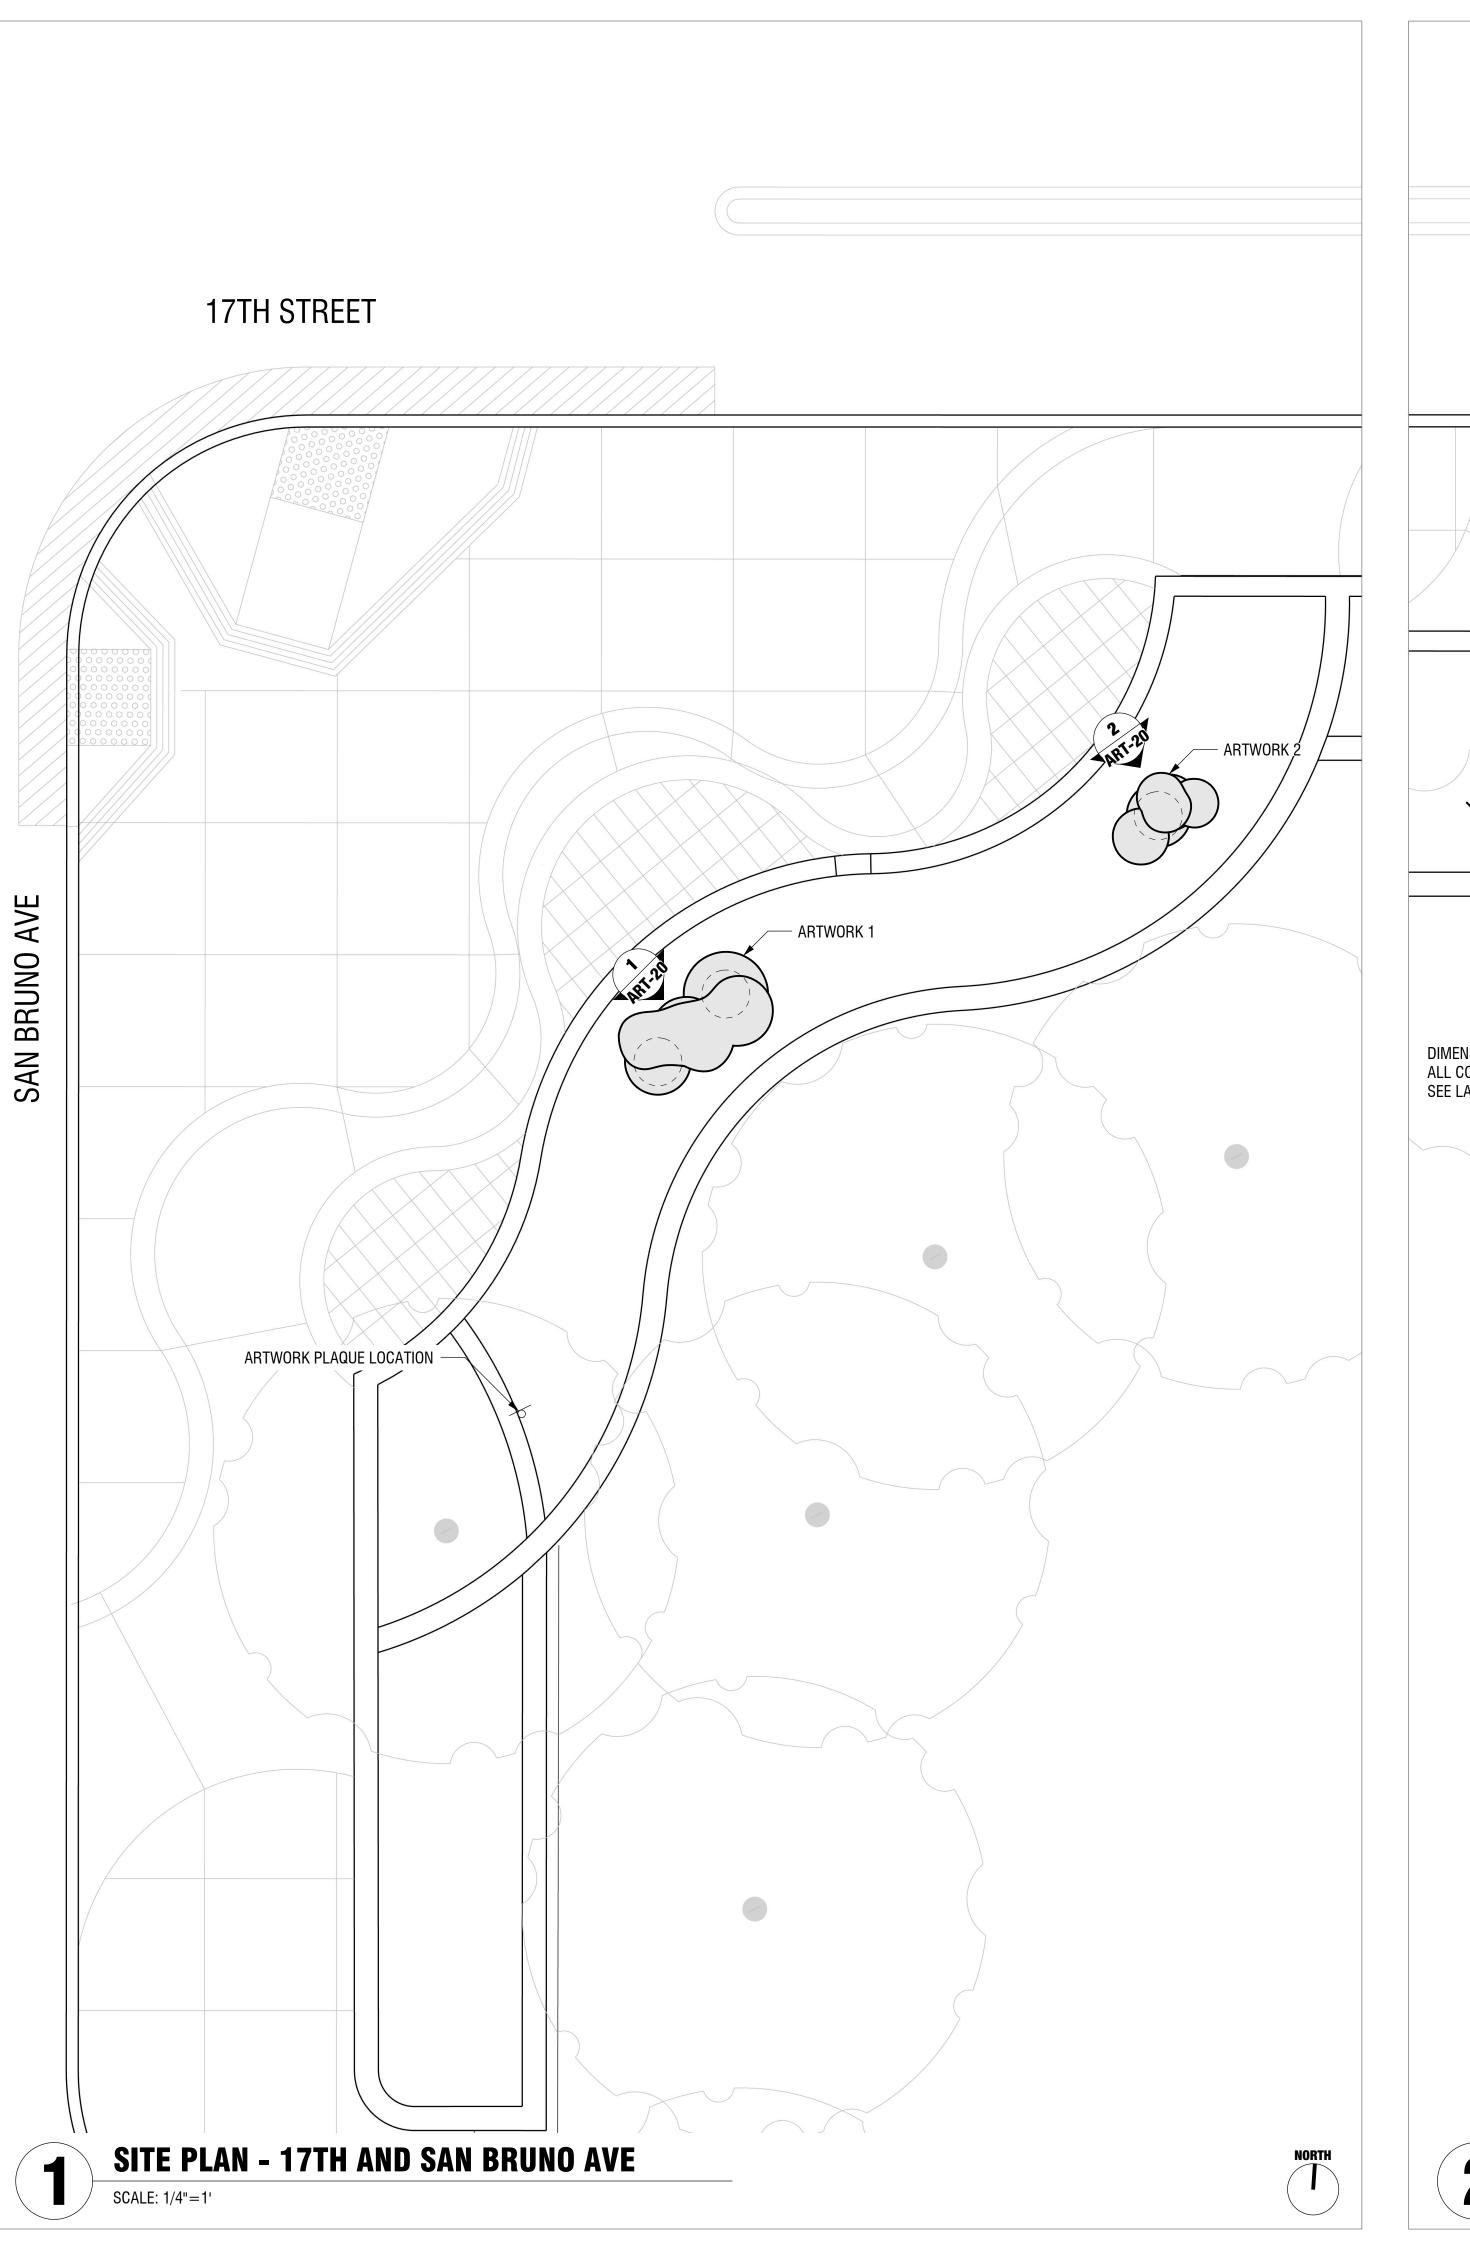

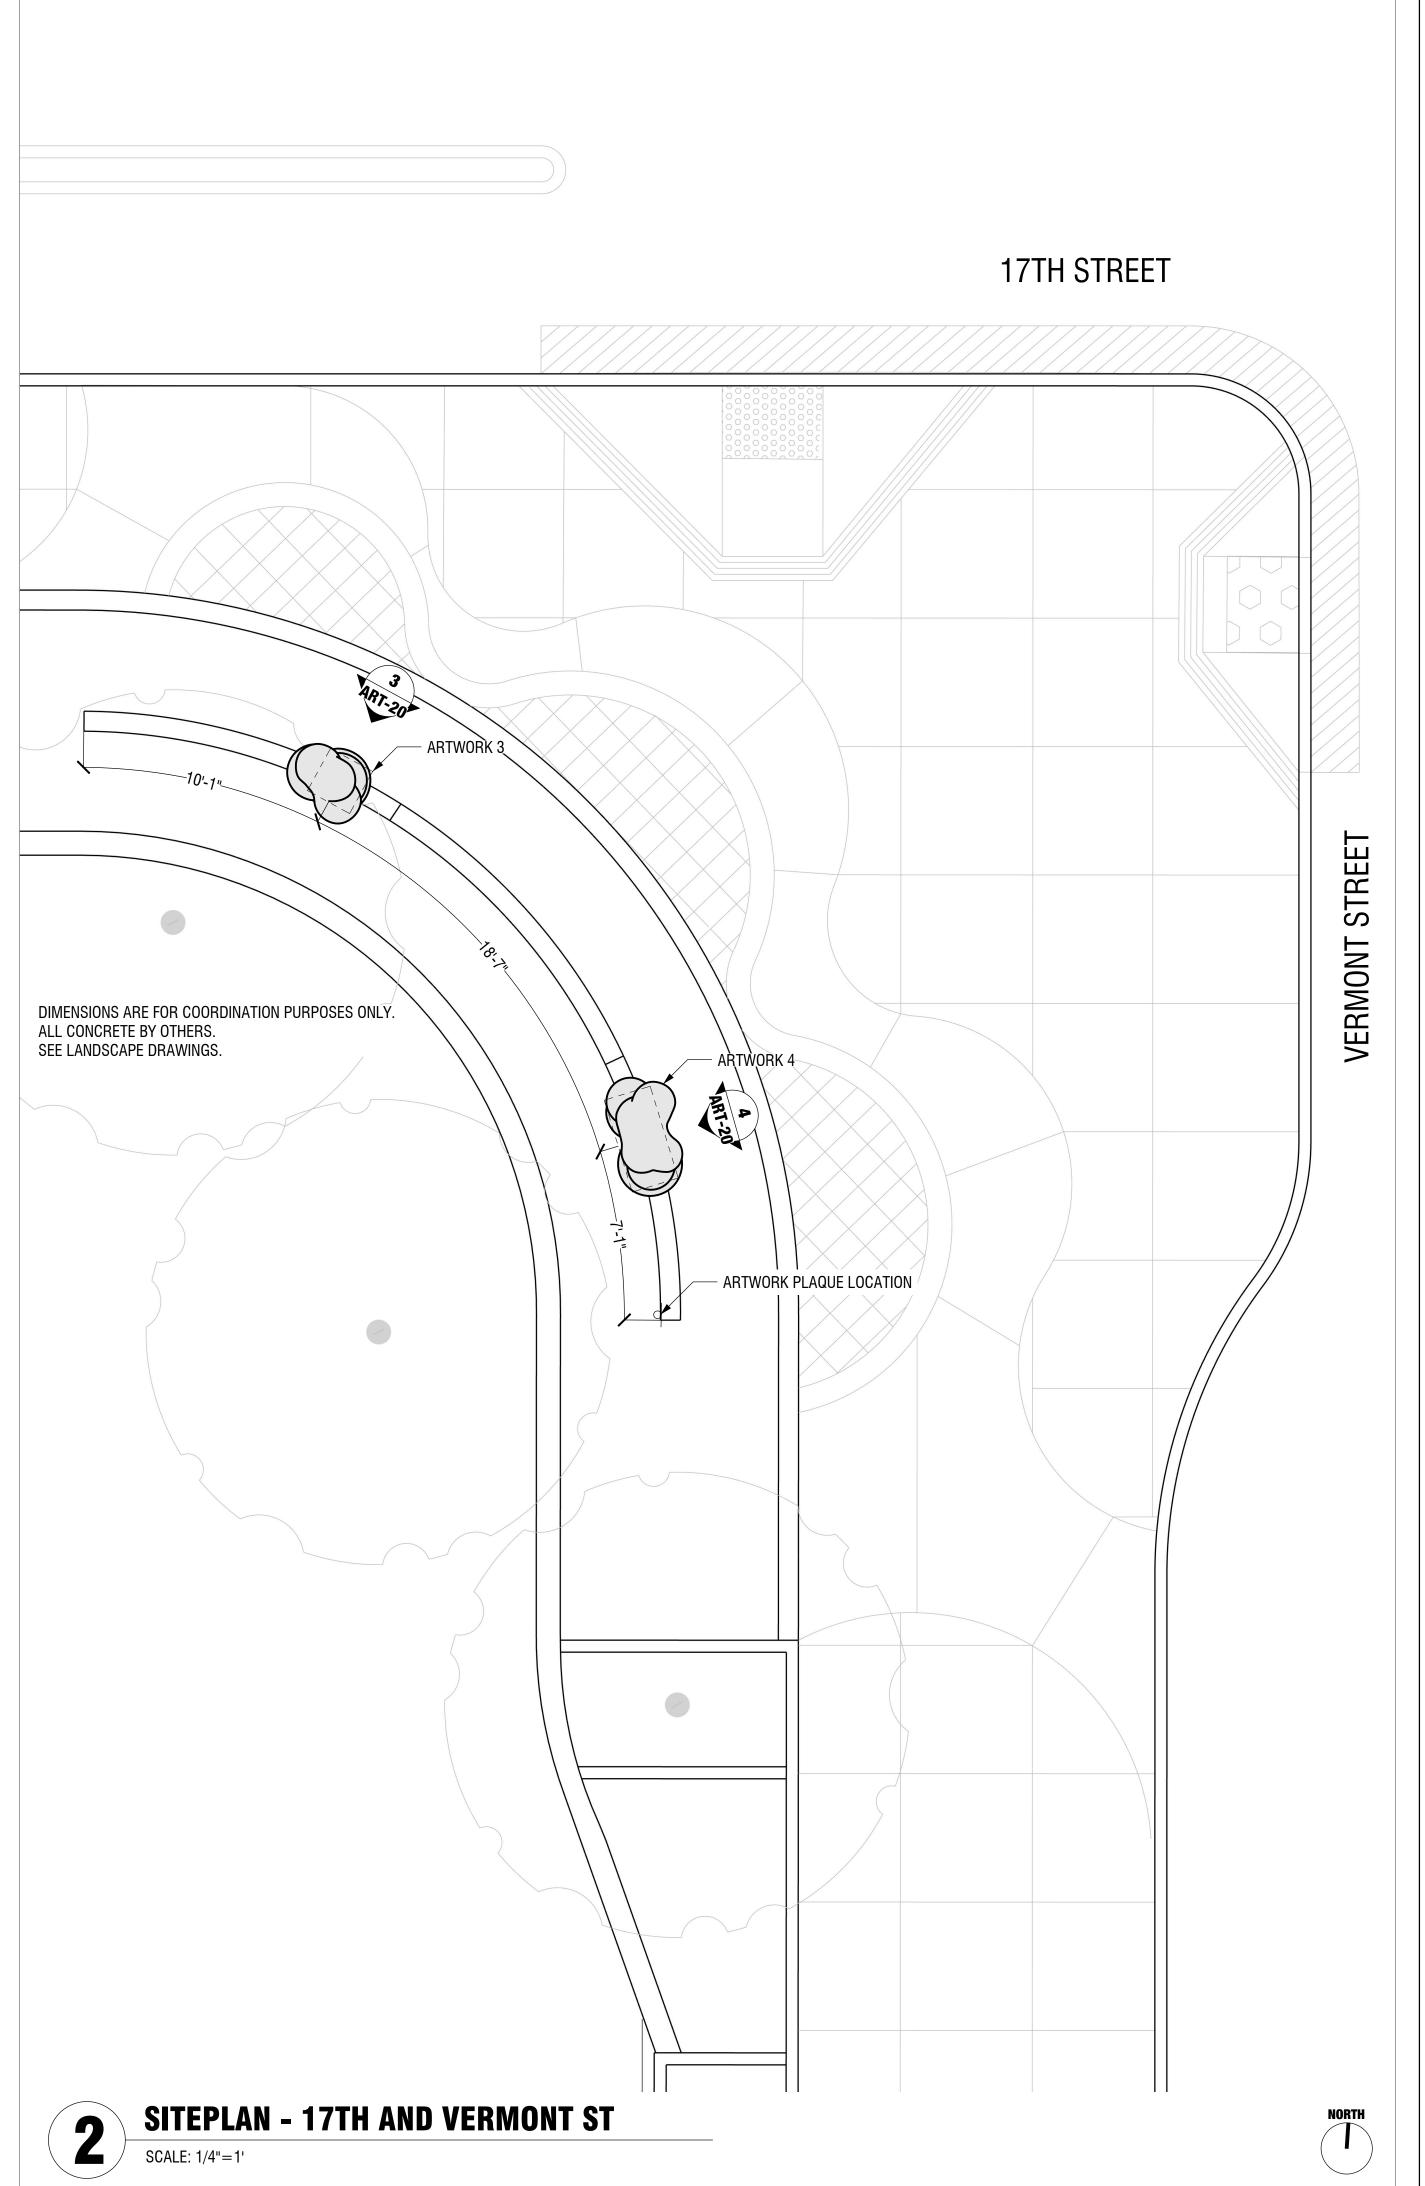

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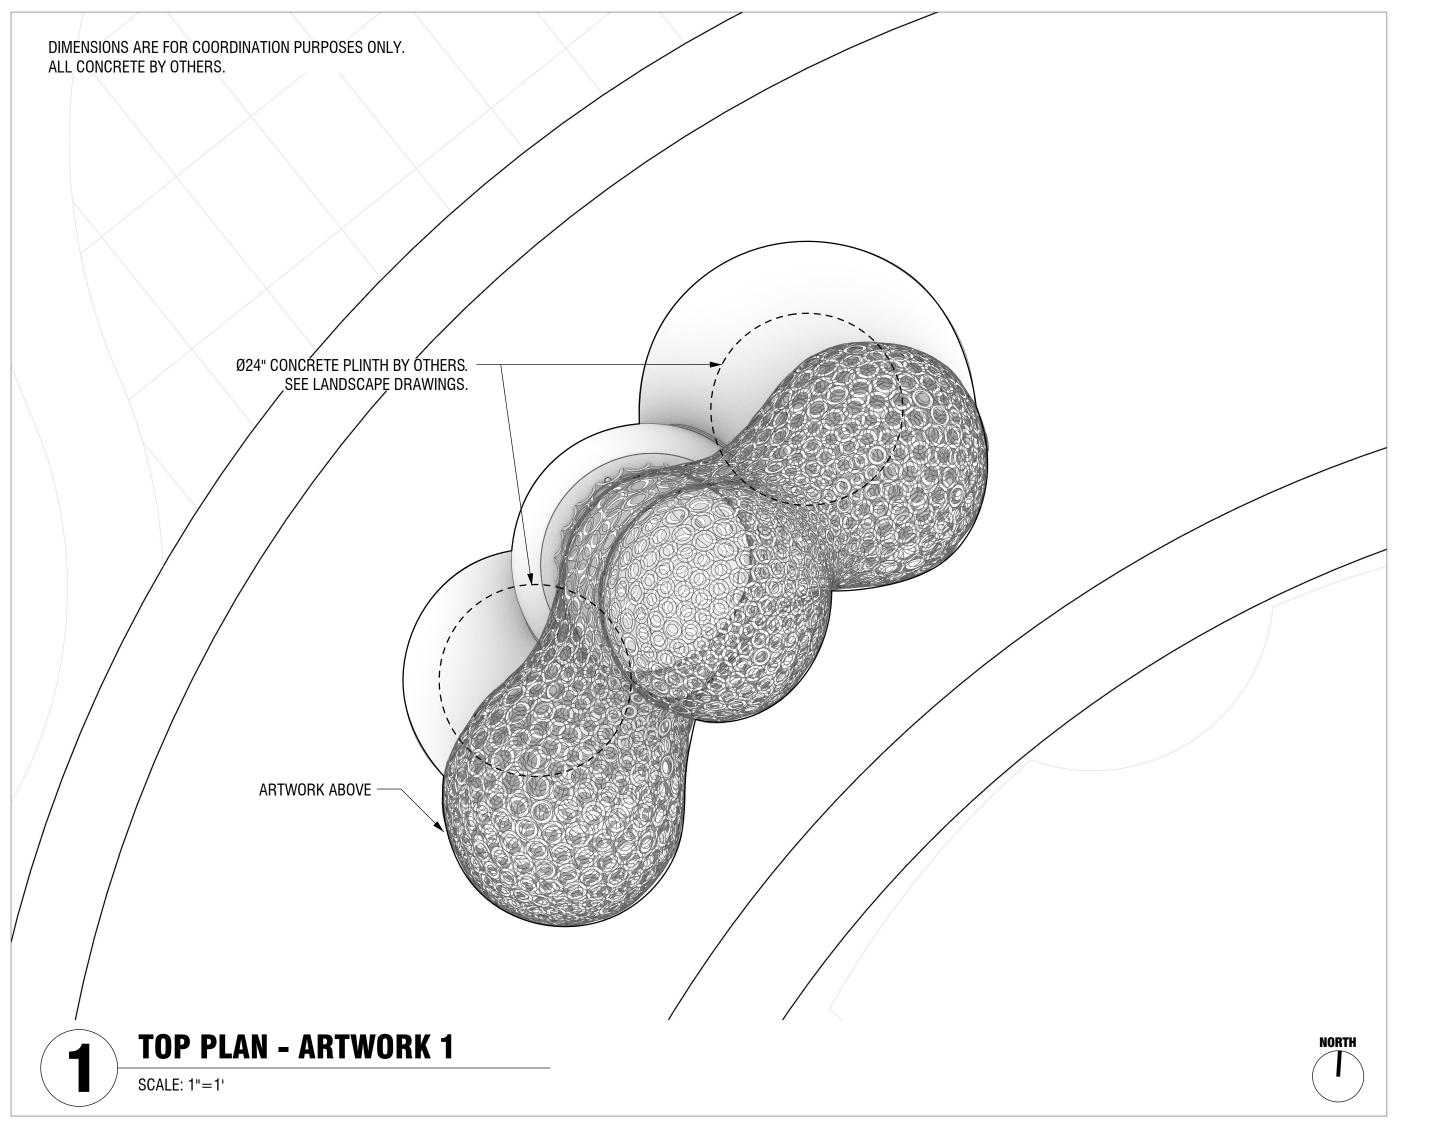
AND SAN BRUNO AVE


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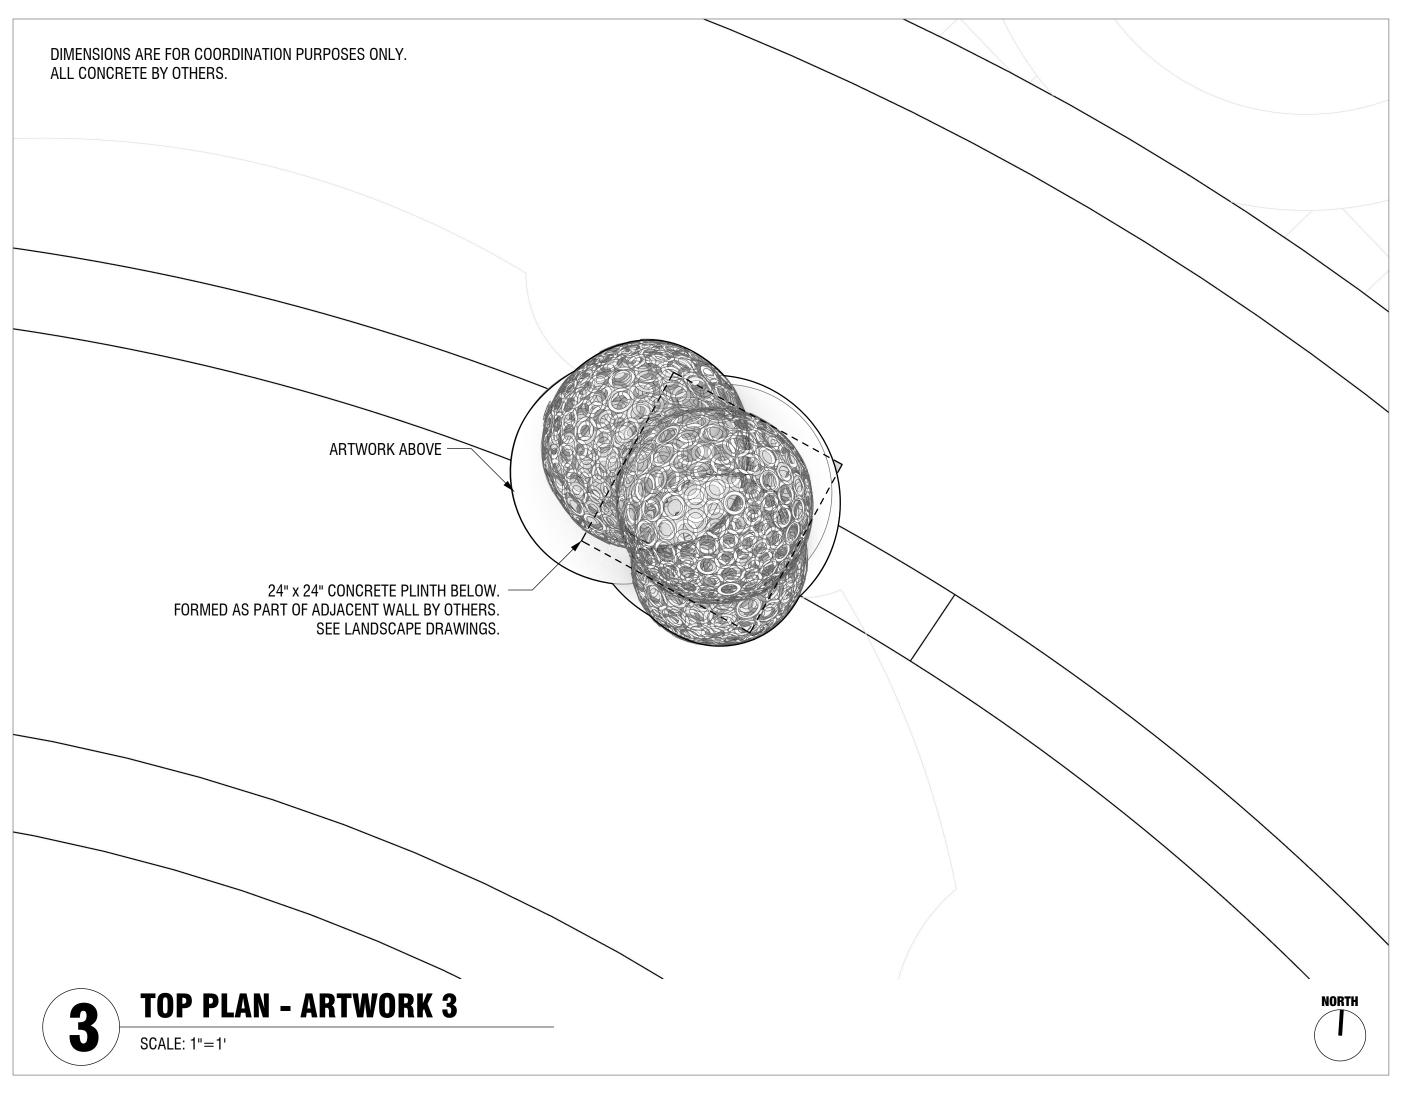
SHEET TITLE SITE PLANS


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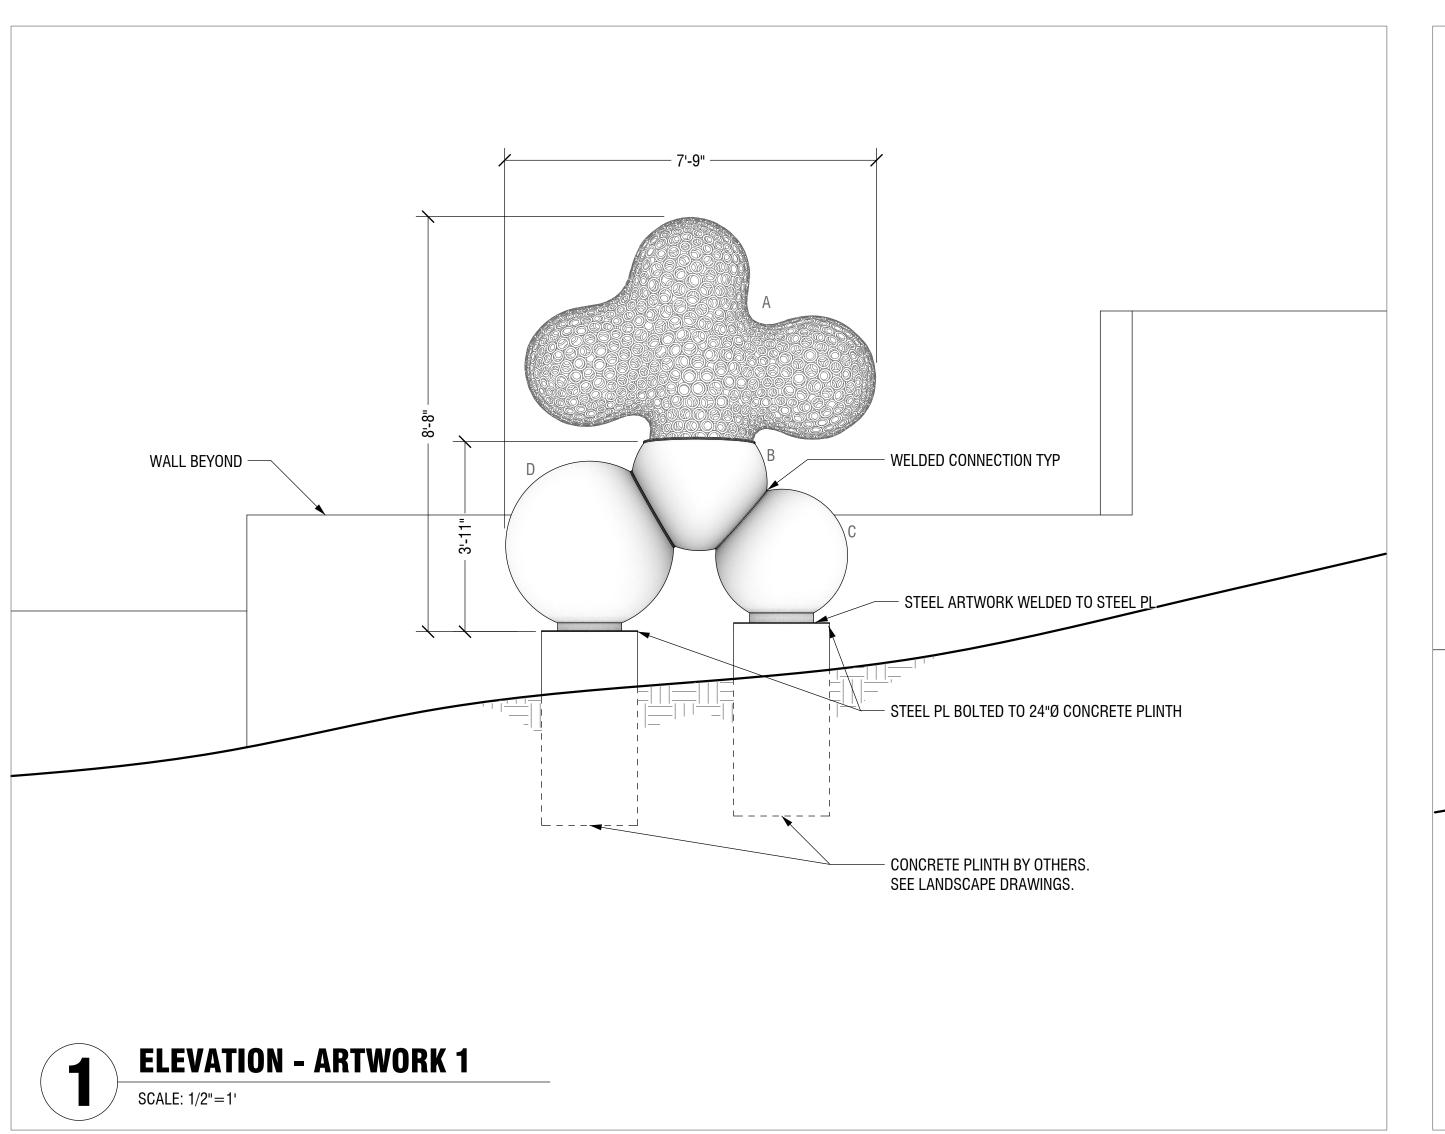
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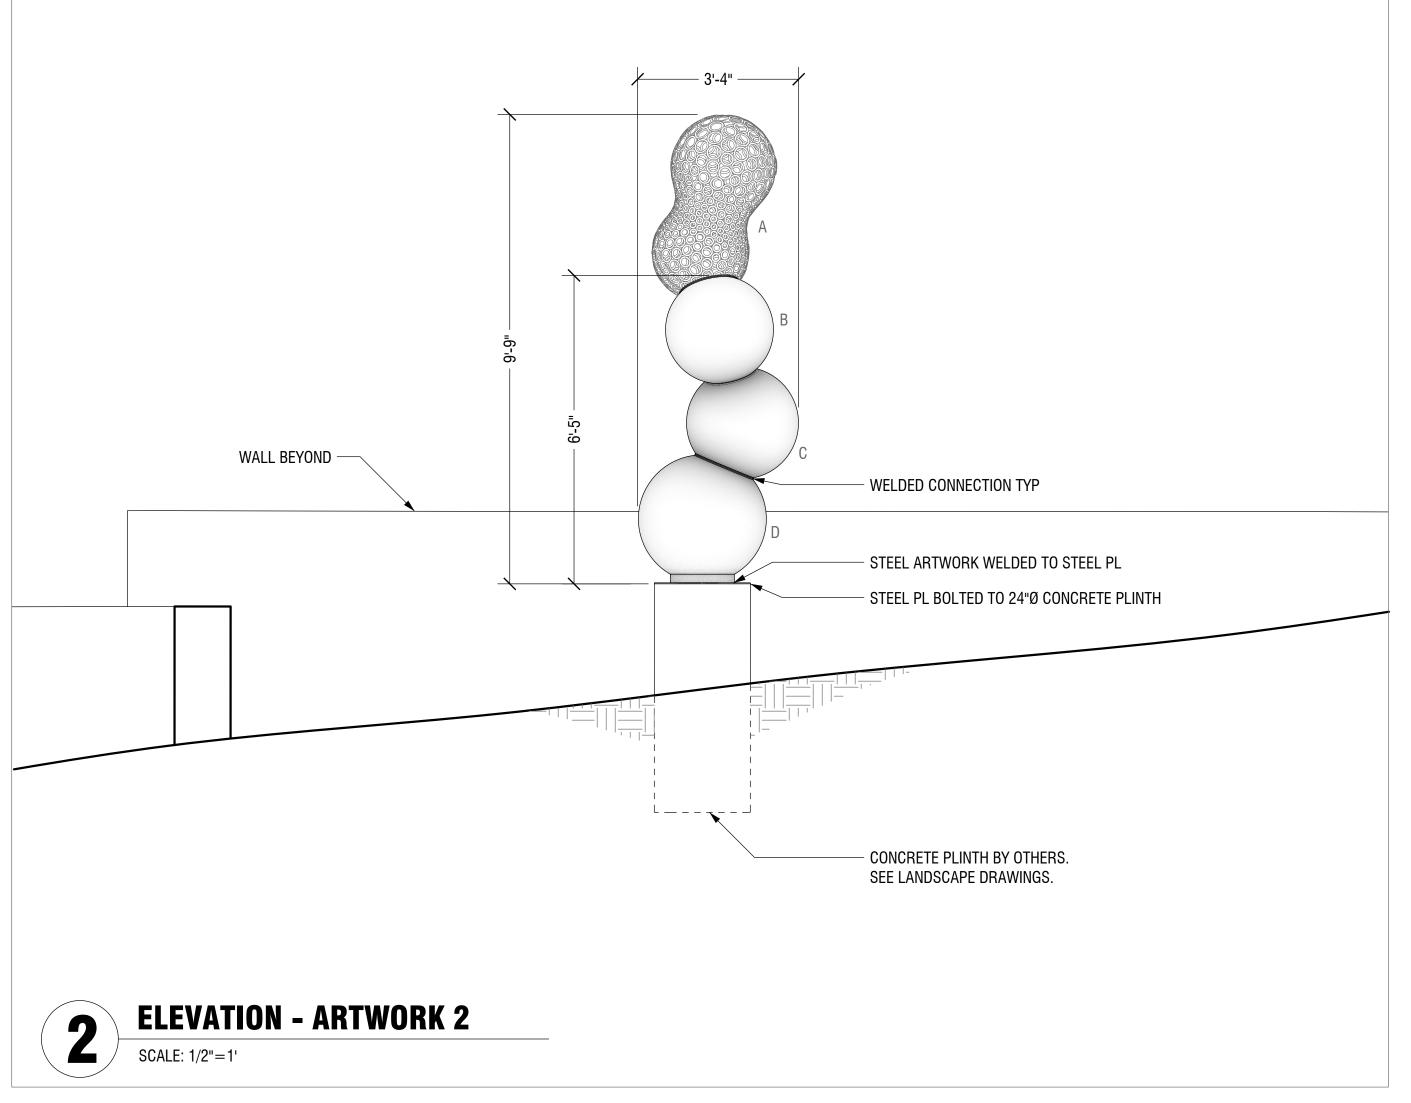
SHEET TITLE TOP PLANS


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AS NOTED ON DRAWINGS


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SHEET TITLE ELEVATIONS


DRAWING SCALE
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SHEET SIZE: 24 x 36

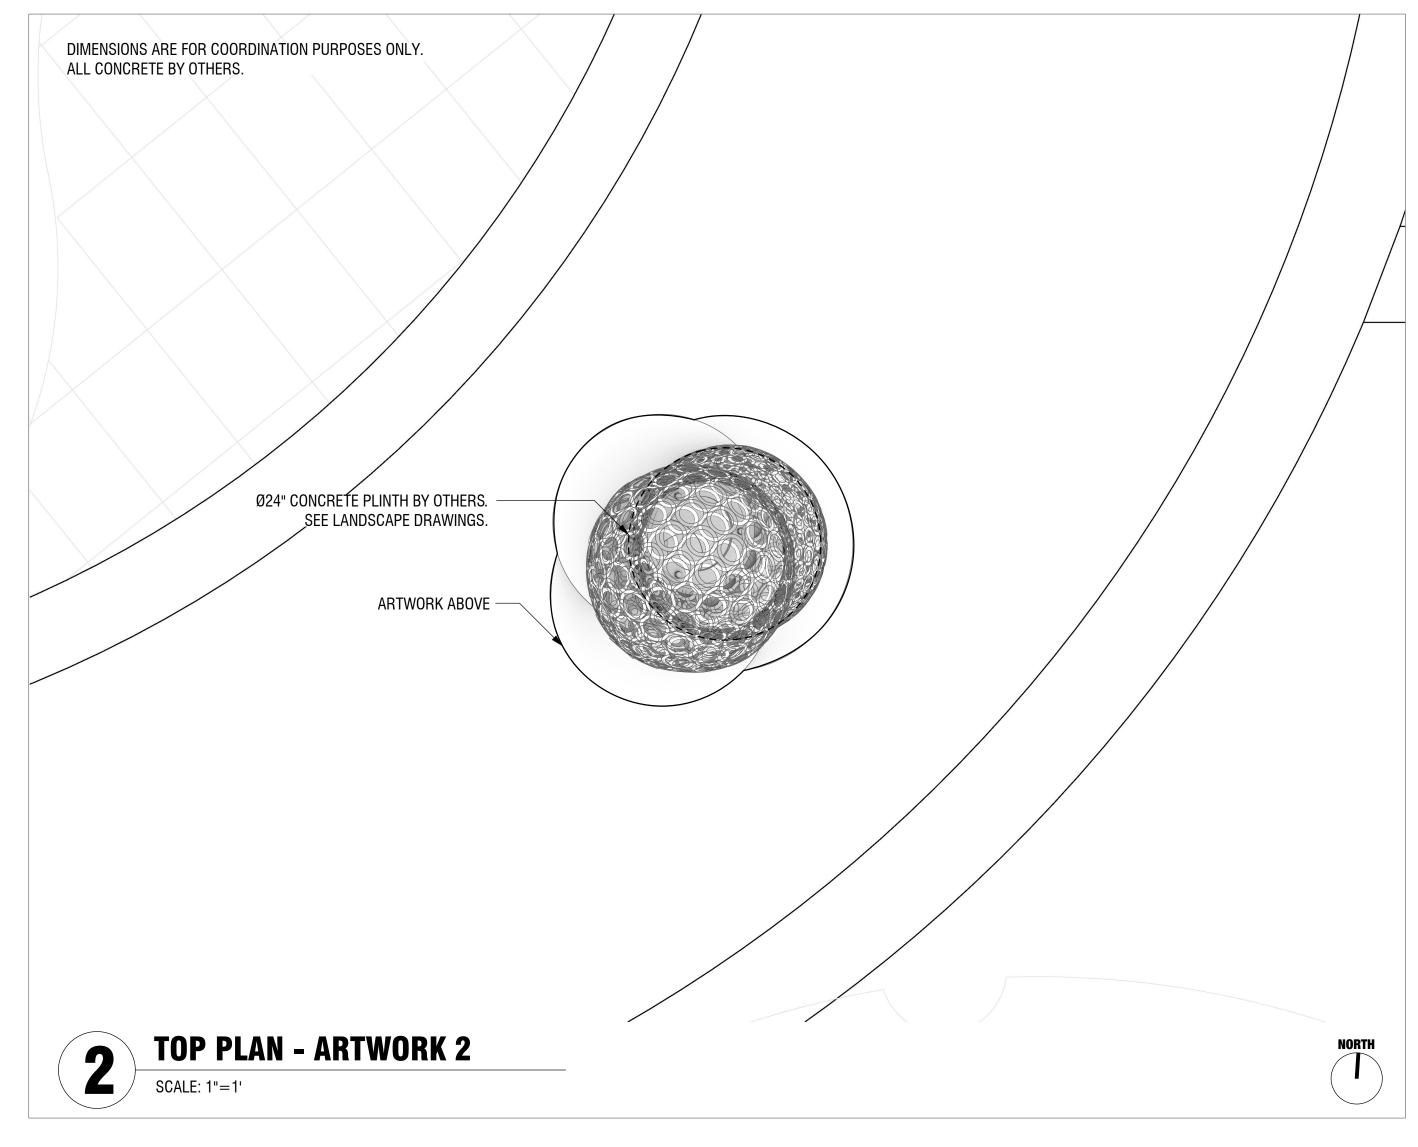
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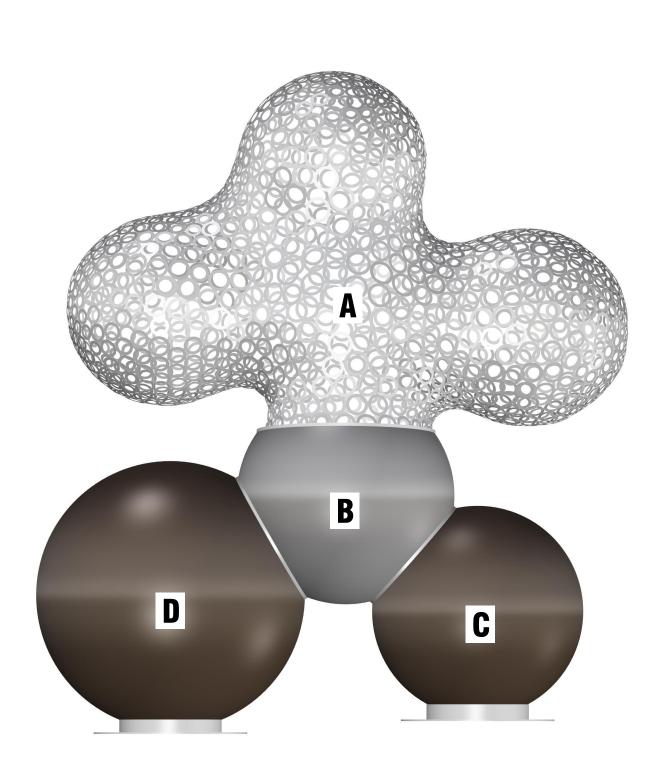
ARTWORK ID	PART ID	MATERIAL	FINISH	SURFACE AREA
1	А	18GA 316 SS	SATIN FINISH	33 SQFT
1	В	14GA 316 SS	SATIN FINISH	15 SQFT
1	С	14GA 316 SS	PAINTED (SEE DETAIL 4)	24 SQFT
1	D	14GA 316 SS	PAINTED (SEE DETAIL 4)	39 SQFT
2	А	18GA 316 SS	SATIN FINISH	12 SQFT
2	В	14GA 316 SS	SATIN FINISH	14 SQFT
2	С	14GA 316 SS	SATIN FINISH	15 SQFT
2	D	14GA 316 SS	PAINTED (SEE DETAIL 4)	20 SQFT
3	А	18GA 316 SS	SATIN FINISH	14 SQFT
3	В	14GA 316 SS	SATIN FINISH	13 SQFT
3	С	14GA 316 SS	PAINTED (SEE DETAIL 4)	14 SQFT
3	D	14GA 316 SS	PAINTED (SEE DETAIL 4)	20 SQFT
4	А	18GA 316 SS	SATIN FINISH	18 SQFT
4	В	14GA 316 SS	SATIN FINISH	13 SQFT
4	С	14GA 316 SS	SATIN FINISH	10 SQFT
4	D	14GA 316 SS	PAINTED (SEE DETAIL 4)	14 SQFT
4	Е	14GA 316 SS	SATIN FINISH	10 SQFT

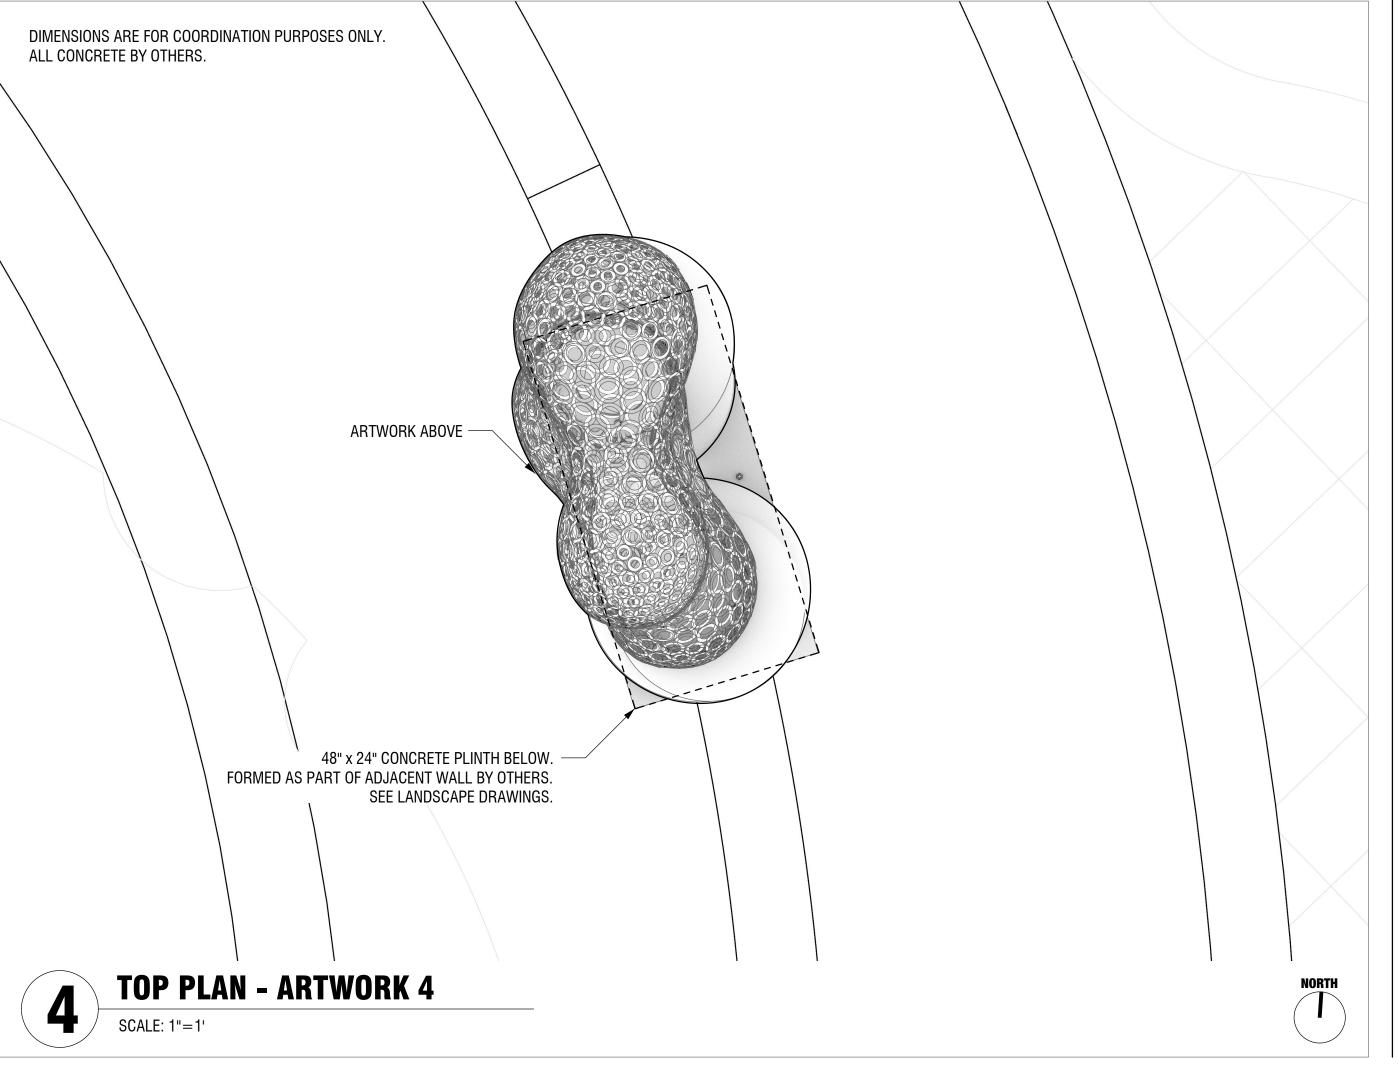

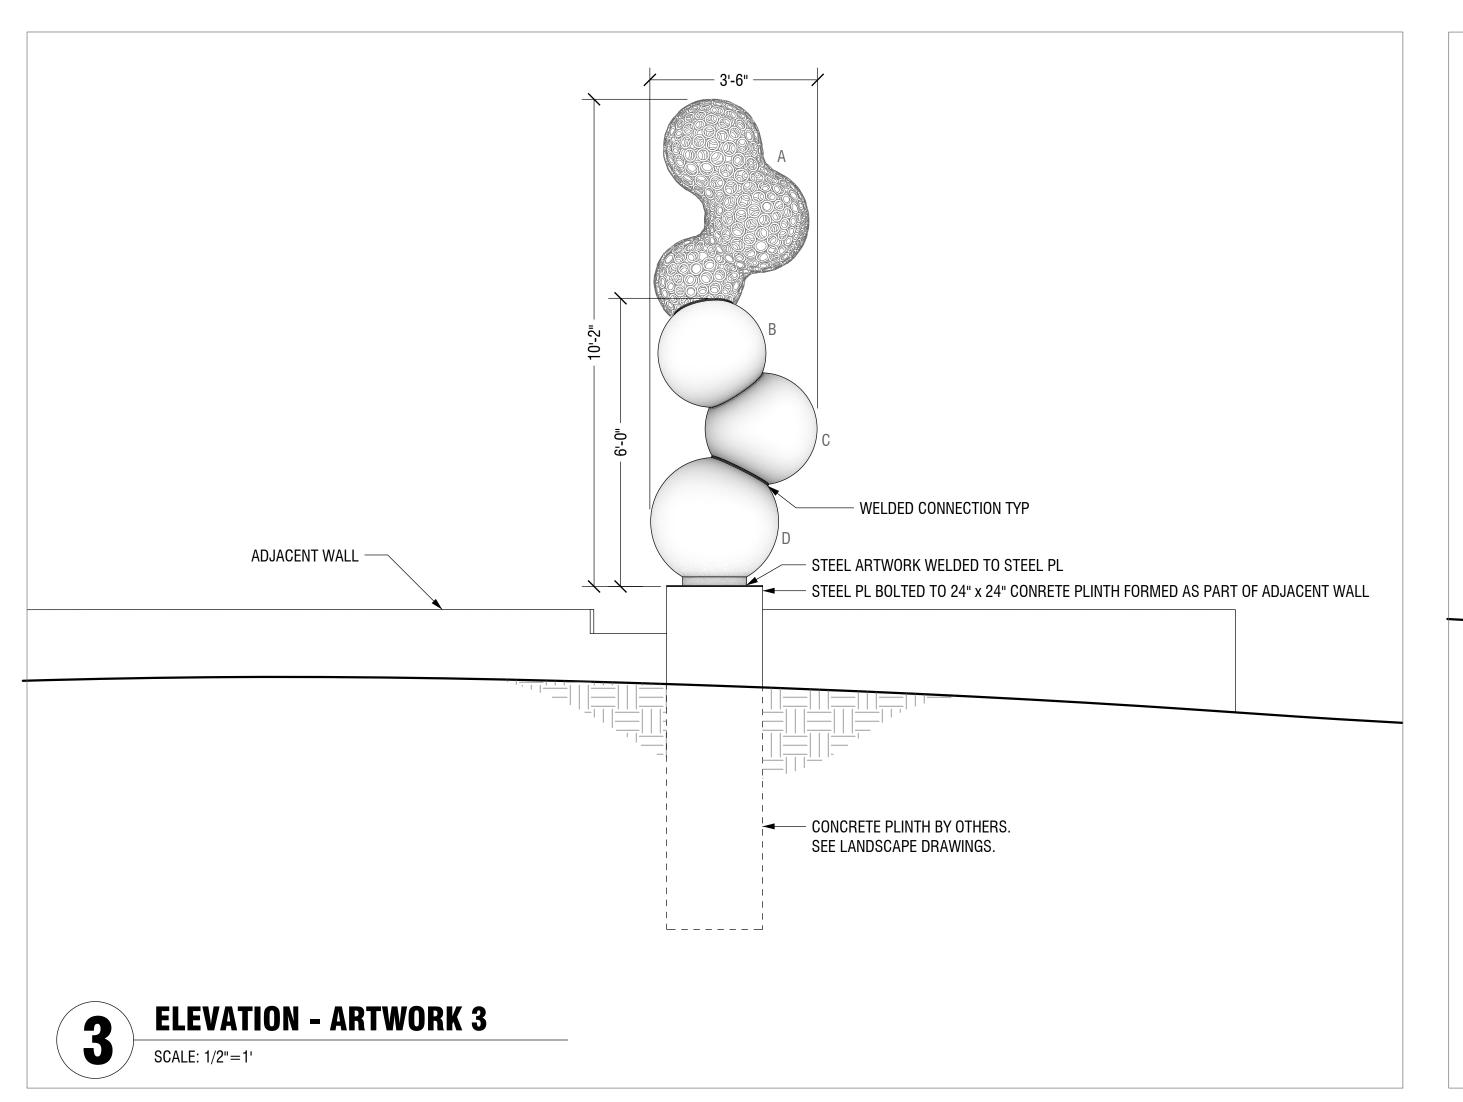
MATERIAL AND FINISH SCHEDULE

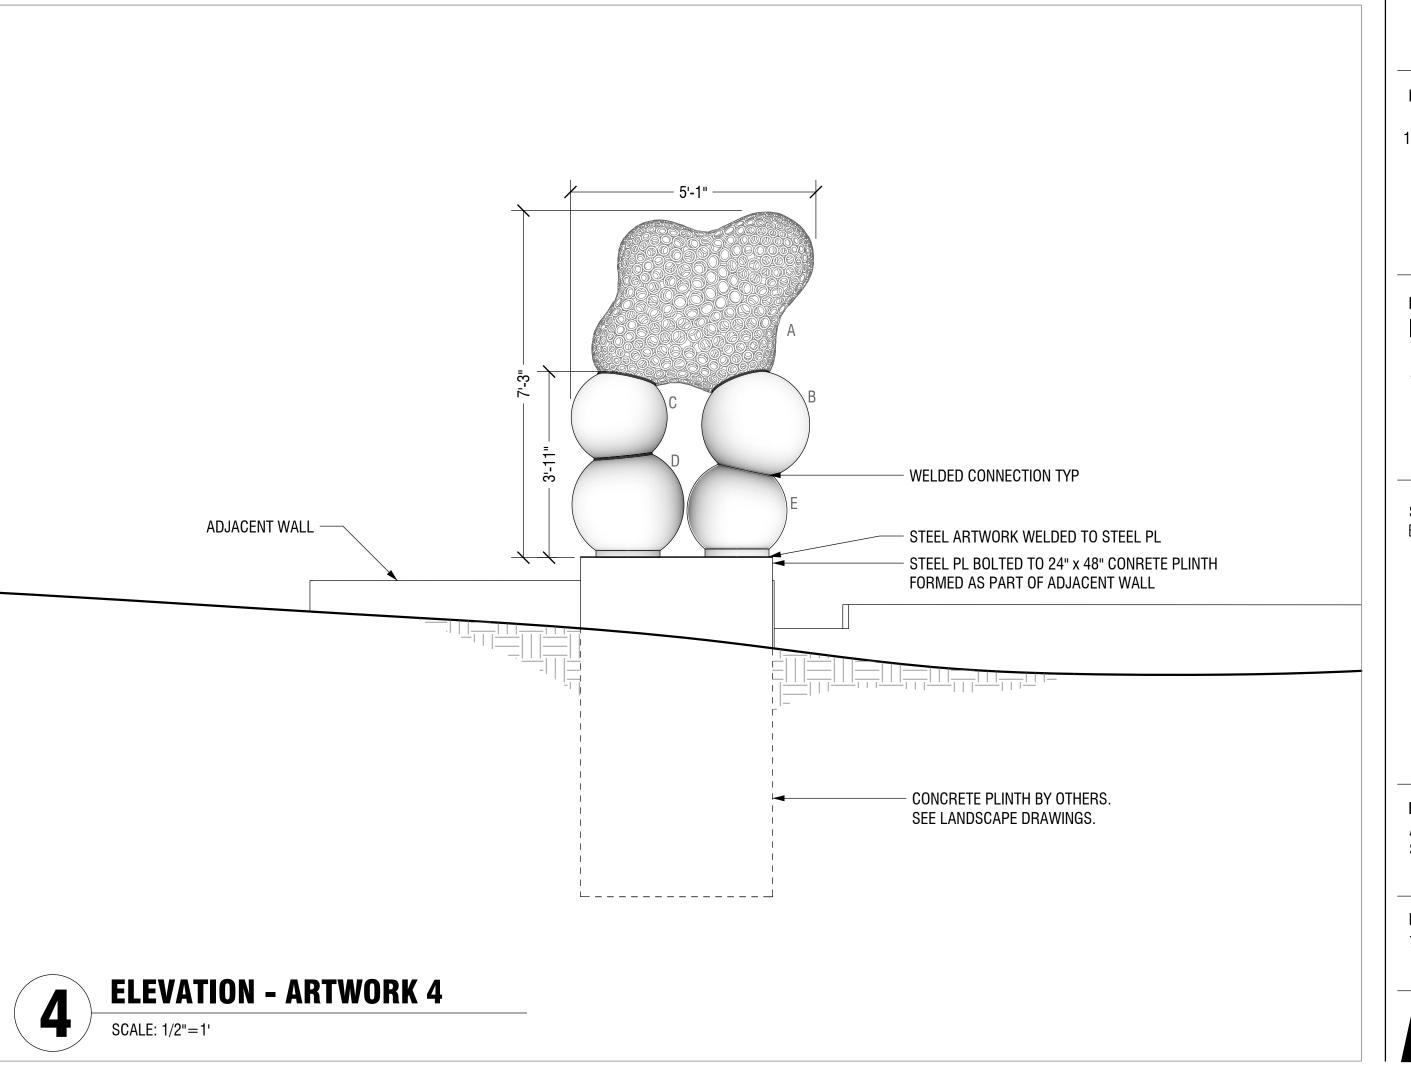

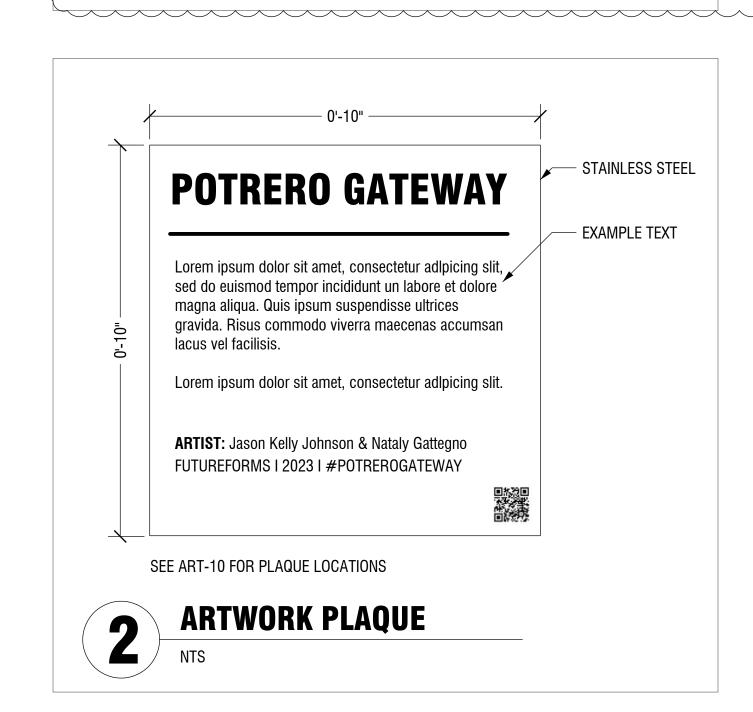


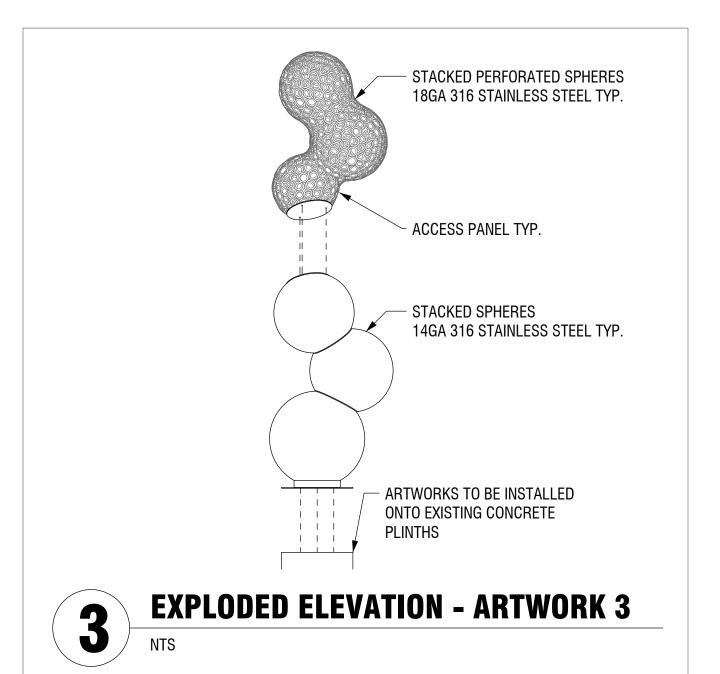


ARTWORK 1

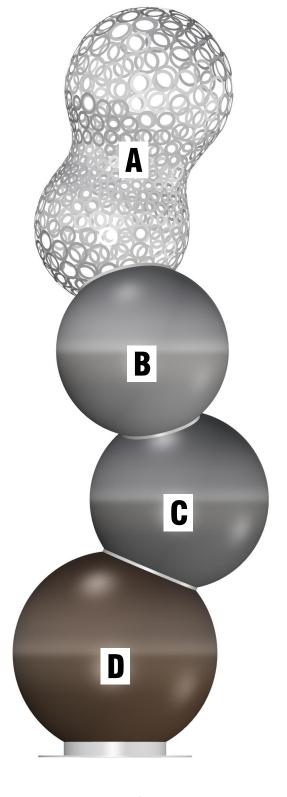

ARTWORK 2

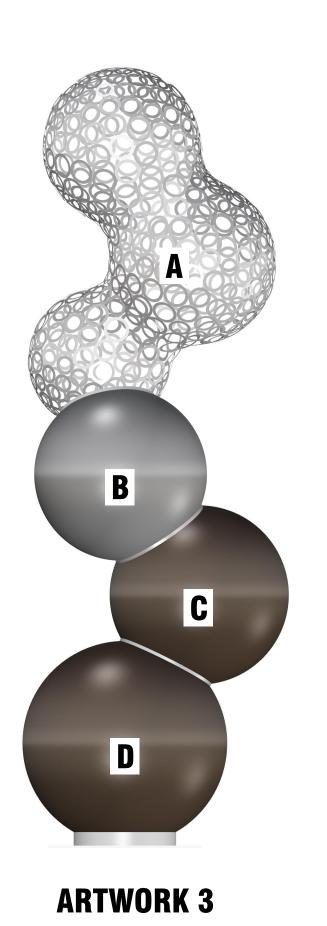


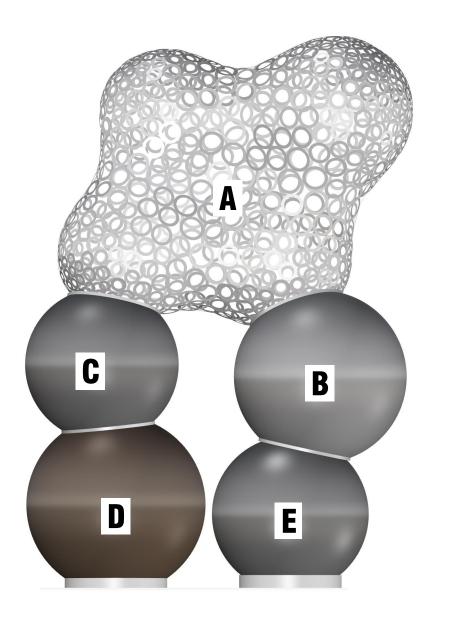

ARTWORK 4



SATIN FINISHED STAINLESS STEEL

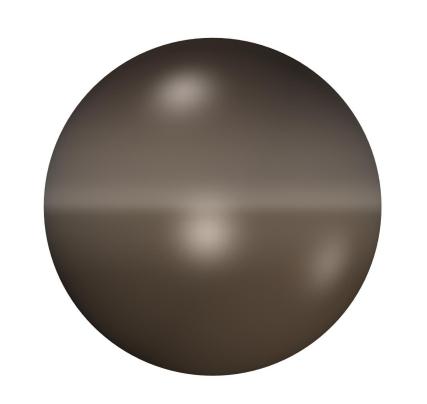

STAINLESS STEEL WITH "BROWN BRONZE" FLUOROPOLYMER BASED METALLIC COATING

ARTWORK MATERIALS

ARTIST:

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SAN FRANCISCO, CA 94107 JASON KELLY JOHNSON jason@futureforms.us (415) 255-4879

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SHEET TITLE

TYPICAL MATERIALS AND ASSEMBLY

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- 2. THESE GENERAL NOTES APPLY EXCEPT WHERE SPECIFICALLY SHOWN BY NOTES ON DRAWINGS AND/OR DETAILS.
- 3. NOTES AND DETAILS ON DRAWINGS SHALL TAKE PRECEDENCE OVER GENERAL NOTES.
- THE CONTRACTOR SHALL COMPARE STRUCTURAL DRAWINGS WITH DRAWINGS OF OTHER DISCIPLINES WITH REFERENCE TO MATERIALS, LAYOUT, DIMENSIONS AND ELEVATIONS BEFORE STARTING WORK, AND ANY DISCREPANCIES SHALL BE REPORTED TO THE ARCHITECT FOR DIRECTION.
- 5. THE CONTRACTOR SHALL VERIFY ALL DIMENSIONS AS SHOWN ON DRAWINGS. THE CONTRACTOR SHALL REPORT ANY VARIATION THAT WILL MODIFY THE STRUCTURAL SYSTEM OR ANY STRUCTURAL ELEMENT TO THE STRUCTURAL ENGINEER.
- DETAILS AND NOTES SHOWN IN THIS SET OF DRAWINGS AND TITLED "TYPICAL" ARE TYPICAL AND SHALL APPLY UNLESS OTHERWISE NOTED. TYPICAL DETAILS REPRESENT THE GENERAL INTENT FOR ALL DETAILING NOT NOTED OR SHOWN IN SPECIFIC DETAILS OR ON PLANS.
- 7. THE STRUCTURAL DRAWINGS INDICATE PRINCIPAL CONSTRUCTION DETAILS BUT DO NOT ILLUSTRATE EVERY CONDITION. DETAILS OF CONSTRUCTION NOT SPECIFICALLY SHOWN SHALL BE OF THE SAME NATURE AS SHOWN FOR SIMILAR CONDITIONS.
- B. DO NOT SCALE STRUCTURAL DRAWINGS, USE WRITTEN DIMENSIONS. IF DIMENSIONS ARE OMITTED OR NOT CLEAR, CONTACT THE ARCHITECT.
- 9. DIMENSION LINES ON STRUCTURAL DRAWINGS ARE TO CENTER LINES OF ELEMENTS, UNLESS OTHERWISE NOTED.
- 10. THE CONTRACT STRUCTURAL DRAWINGS AND SPECIFICATIONS REPRESENT THE FINISHED STRUCTURE. THEY DO NOT INDICATE THE METHOD OF CONSTRUCTION.
- 11. THE CONTRACTOR SHALL PROVIDE ALL MEASURES NECESSARY TO PROTECT THE STRUCTURE DURING CONSTRUCTION. SUCH MEASURES SHALL INCLUDE, BUT NOT BE LIMITED TO, BRACING, SHORING, GUYING OR OTHER TEMPORARY SUPPORT TO ENSURE CORRECT AND ACCURATE STRUCTURE GEOMETRY.
- 12. THE CONTRACTOR SHALL BE EXPECTED TO BE THOROUGHLY FAMILIAR WITH THE BUILDING SITE CONDITIONS, GRADES, DRAWINGS AND SPECIFICATIONS, MATERIAL DELIVERY FACILITIES AND ALL OTHER MATTERS AND CONDITIONS WHICH MAY AFFECT THE OPERATION AND COMPLETION OF WORK. THE CONTRACTOR SHALL ASSUME ALL RISKS CONCERNED WITH THE AFOREMENTIONED SITUATIONS, ACTIVITIES AND/OR OPERATIONS.
- 13. THE CONTRACTOR SHALL TAKE PRECAUTIONARY MEASURES TO ENSURE THAT ALL PROPERTY IS PROTECTED DURING CONSTRUCTION. ANY DAMAGED OR CHANGED CONDITIONS SHALL BE REPAIRED AND RESTORED TO THE PRE—CONSTRUCTION CONDITIONS. THE CONTRACTOR SHALL REPAIR ANY DAMAGE AT HIS/HER OWN EXPENSE.
- 14. THE CONTRACTOR SHALL ASSUME SOLE AND COMPLETE RESPONSIBILITY FOR THE JOB SITE CONDITIONS DURING THE COURSE OF CONSTRUCTION OF THIS PROJECT, INCLUDING THE SAFETY OF ALL THE PERSONNEL AND PROPERTY. THIS REQUIREMENT SHALL APPLY CONTINUOUSLY AND SHALL NOT BE LIMITED TO NORMAL WORKING HOURS

II. <u>CONCRETE SCREW ANCHORS</u>

- . SIMPSON "TITEN HD" (ICC ESR-2713) HEAVY DUTY CONCRETE SCREW ANCHORS SHALL BE USED FOR ANCHORS EMBEDDED IN CONCRETE. INSTALLATION PER MANUFACTURERS SPECIFICATIONS. ALTERNATIVE ANCHORING SYSTEMS MAY BE USED ONLY WITH PRIOR WRITTEN APPROVAL BY STRUCTURAL ENGINEER.
- TEST THE FOLLOWING PERCENT OF INSTALLED ANCHORS:
 A. 20% OF ANCHORS UNLESS OTHERWISE NOTED ON DRAWINGS

3. TORQUE TEST LOAD VALUES

TORQUE TEST BOLT DIAMETER	LOAD VALUES MINIMUM EMBEDMENT	TORQUE LOAD
3/8"	2 ½"	50 FT-LBS.
1/2"	3 ¼"	65 FT-LBS.
5/8"	4"	100 FT-LBS.
3/4"	5 ½"	150 FT-LBS.

4. IF ANY ANCHOR SHOULD FAIL, IT SHALL BE REPLACED AT THE CONTRACTORS EXPENSE.

III. <u>STRUCTURAL STEEL</u>

- 1. MATERIALS:
 ALL OTHER ROLLED SHAPES, PLATES & BARS:
 ANCHOR BOLTS (RODS)
 ASTM A36
 OR ASTM A36
- 2. FABRICATION AND CONSTRUCTION SHALL CONFORM TO THE STEEL CONSTRUCTION MANUAL, SPECIFICATIONS AND CODES, 13TH EDITION, BY AMERICAN INSTITUTE OF STEEL CONSTRUCTION (AISC).

3. WELDIN

- A. ALL SHOP AND FIELD WELDING SHALL BE IN ACCORDANCE WITH STRUCTURAL STEEL WELDING CODE, AWS D1.1.
- B. 70 KSI ELECTRODES SHALL BE USED AT ALL WELDED STEEL CONNECTIONS.C. ALL WELDING SHALL BE DONE BY CERTIFIED WELDERS.
- D. A WELDING PROCEDURE SPECIFICATION (WPS) SHALL BE DEVELOPED WITH THE INFORMATION REQUIRED BY AWS D1.1. THE WPS SPECIFICATION SHALL BE SUBMITTED TO THE ENGINEER FOR REVIEW, AND SHALL ALSO BE PROVIDED TO THE OWNER, ARCHITECT AND BUILDING OFFICIAL. THE WPS SHALL INCLUDE A LIST OF THE POSITION, ELECTRODE STICKOUT, VOLTAGE AND AMPERAGE (WITH ACCEPTABLE LIMITS), BEAD SIZE, WELD SEQUENCE, STRESS RELIEVING AND
- OTHER PERTINENT DATA.

 E. ALL WELDS SHALL BE STARTED AND ENDED ON RUNOFF TABS WHERE PRACTICAL. ALL RUNOFF TABS SHALL BE REMOVED.
- F. WELD DAMS SHALL NOT BE ALLOWED PER AWS D1.1.
 G. OWNER SHALL RETAIN A TESTING LABORATORY TO INSPECT AND TEST WELDS
- (SHOP AND FIELD) AS FOLLOWS:

 (I) PROVIDE SPECIAL INSPECTION FOR ALL WELDS.
- (II) MEASURE 25% OF FILLET WELDS AND CHECK FINAL PASS OF 25% OF MULTI-PASS FILLET WELDS AND PARTIAL PENETRATION WELDS BY MAGNETIC PARTICLE TESTING.
- (III) TEST ALL COMPLETE PENETRATION WELDS ULTRASONICALLY.
 H. ALL DEFECTIVE WELDS, AS ESTABLISHED FROM INSPECTION AND TESTING SHALL BE GROUND OUT, REPAIRED AND RETESTED AT THE CONTRACTOR'S EXPENSE.
- 4. BOLT HOLES IN STEEL SHALL BE 1/16" LARGER THAN BOLTS, U.O.N. BOLT HOLES IN COLUMN BASE PLATES MAY BE OVERSIZED PER AISC REQUIREMENTS. ALL BOLT HOLES SHALL BE DRILLED OR PUNCHED. BURNING OF BOLT HOLES IS NOT PERMITTED.
- 5. BEFORE FABRICATION, SHOP DRAWINGS FOR ALL STRUCTURAL STEEL SHALL BE SUBMITTED TO THE ENGINEER FOR REVIEW.

IV. <u>HAZARDOUS MATERIALS ON SITE</u>

1. TUAN AND ROBINSON, STRUCTURAL ENGINEERS ASSUMES NO RESPONSIBILITY FOR THE MANAGEMENT OF HAZARDOUS MATERIALS THAT MAY BE ON THE SITE. THE CONTRACTOR SHALL BE RESPONSIBLE FOR INSURING THAT PERSONNEL WITHIN THE WORK AREA ARE PROTECTED FROM EXPOSURE TO HAZARDOUS MATERIALS. IF MATERIALS ARE DISCOVERED THAT MAY BE HAZARDOUS, THE CONTRACTOR SHALL IMMEDIATELY NOTIFY THE OWNER AND CEASE WORK UNTIL CONDITIONS CAN BE MAINTAINED IN COMPLIANCE WITH ALL APPLICABLE REGULATIONS.

V. <u>SPECIAL INSPECTION</u>

THE OWNER SHALL EMPLOY A SPECIAL INSPECTOR TO PERFORM SPECIAL INSPECTION IN ACCORDANCE WITH SECTION 1704 OF THE 2019 CBC AS A MINIMUM. THE SPECIAL INSPECTOR SHALL BE FROM AN APPROVED SPECIAL INSPECTION AGENCY. THE FOLLOWING ITEMS OF WORK REQUIRE SPECIAL INSPECTION:

A. BOLTS INSTALLED IN CONCRETE

B. STRUCTURAL WELDING

2. THE TESTING AND INSPECTION AGENCY SHALL COMPILE TESTING AND INSPECTION REPORTS DETAILING THE ITEMS OF WORK WHICH HAVE BEEN INSPECTED. A COPY OF THE REPORTS SHALL BE SENT TO THE OWNER, ARCHITECT, STRUCTURAL ENGINEER AND CONTRACTOR FOR REVIEW.

VI. SPECIAL INSPECTION PROGRAM

- BOLTS INSTALLED IN CONCRETE (CONTINUOUS INSPECTION DURING PLACEMENT): SPECIAL INSPECTOR SHALL PERFORM SPECIAL INSPECTION PRIOR TO AND DURING THE PLACEMENT OF CONCRETE AROUND BOLTS.
- WELDING (PERIODIC INSPECTION): SPECIAL INSPECTION OF WELDING SHALL BE IN ACCORDANCE WITH THE 2019 CBC, SECTION 1704, AWS D1.1 AND NOTE III.3 ON THIS SHEET. INSPECTION SHALL PREFORM OR OBSERVE THE FOLLOWING:
- A. PERFORM VERIFICATION OF AVAILABILITY OF WPS AND MANUFACTURER CONSUMABLE CERTIFICATES.
- B. OBSERVE MATERIALS AND WELDER IDENTIFICATIONS.
 C. OBSERVE FIT—UP OF FILLET AND GROOVE WELDS, AND CONFIGURATION AND
- FINISH OF ACCESS HOLES.
 D. OBSERVE USE OF QUALIFIED WELDERS.
- E. OBSERVE CONTROL AND HANDLING OF CONSUMABLES, NO WELDING OVER CRACKED TACK WELDS, ENVIRONMENTAL CONDITIONS, WPS IS FOLLOWED AND WELDING TECHNIQUES OF WELDERS.
- F. OBSERVE WELDS ARE CLEANED.
- G. PERFORM VERIFICATION THAT WELDS MEET VISUAL ACCEPTANCE CRITERIA, NOTE OF ARC STRIKES, VERIFICATION OF BACKING BARS REMOVAL, VERIFICATION OF WELD TAB REMOVAL, VERIFICATION OF REPAIR ACTIVITIES.
- H. PERFORM DOCUMENTATION OF ACCEPTANCE OR REJECTION OF WELDED JOINT OR MEMBER.
- 3. INSPECTION AND TESTING OF ANCHORS AND DOWELS (PERIODIC INSPECTION):

 A. SPECIAL INSPECTOR SHALL OBSERVE THAT DRILLED HOLES ARE FREE OF DUST AND DEBRIS PRIOR TO PLACEMENT OF NON—SHRINK GROUT OR EPOXY OF DRILLED ANCHORS AND DOWELS OR EXPANSION ANCHORS.
- B. ANCHORS SHALL BE PULL TESTED AS SPECIFIED IN NOTES.
 C. TESTING APPARATUS SHALL BE SUCH THAT IT TESTS NOT ONLY THE ANCHOR IN DIRECT TENSION, BUT ALSO THE ADJACENT CONCRETE FOR CONE FAILURE. IF ANY ANCHOR SHOULD FAIL, IT SHALL BE REPLACED AT THE CONTRACTOR'S EXPENSE. THE IMMEDIATELY ADJACENT ANCHORS SHALL ALSO BE TESTED AT
- THE CONTRACTOR'S EXPENSE.

 D. TEST EQUIPMENT SHALL BE CALIBRATED BY AN APPROVED TESTING
- LABORATORY IN ACCORDANCE WITH STANDARD RECOGNIZED PROCEDURES.

 E. THE FOLLOWING CRITERIA APPLY FOR THE ACCEPTANCE OF INSTALLED ANCHORS: ANCHORS:

 (1) HYDRAULIC BAM METHOD: THE ANCHOR SHALL HAVE NO OBSERVABLE
- (i) HYDRAULIC RAM METHOD: THE ANCHOR SHALL HAVE NO OBSERVABLE MOVEMENT AT THE APPLICABLE TEST LOAD.
 (ii) TESTING SHALL OCCUR 24 HOURS MINIMUM AFTER INSTALLATION OF THE

City and County of San Francisco Department of Building Inspection



London Breed , Mayor Patrick O'Riardan, Interim Director

NOTICE

SPECIAL INSPECTION REQUIREMENTS

Please note that the special inspections shown on the approved plan and checked on the special inspection form issued with the building permit are required for this project. The employment of special inspectors is the direct responsibility of the owner or the engineer/architect of record acting as the owner's representative.

These special inspections are required *in addition to* the called inspections performed by the Department of Building Inspection. The name of special inspector shall be furnished to the district building inspector prior to start of work for which special inspection is required.

For questions regarding the details or extent of required inspection or tests, please call the Plan Checker assigned to this project or **415-558-6132**. If there are any <u>field</u> problems regarding special inspection, please call your District Building Inspector or 415-558-6570.

Before final building inspection is scheduled, documentation of special inspection compliance must be submitted to and approved by the Special Inspection Services staff. To avoid delays in this process, the project owner should request final compliance reports from the architect or engineer of record and/or special inspection agency soon after the conclusion of work requiring special inspection. *The permit will not be finalized without compliance with the special inspection requirements.*

STRUCTURAL OBSERVATION REQUIREMENTS

Structural observation shall be provided as required per Section 1704.5. **The building permit will not be finalized without the compliance of the structural observation requirements.**

Special Inspection Services Contact Information

- 1. Telephone: (415) 558-6132
- 2. Fax: (415) 558-6474
- 3. Email: <u>dbi.specialinspections@sfgov.org</u>
- 4. In Person: 3rd floor at 1660 Mission Street

Note: We are moving towards a 'paperless' mode of operation. All special inspection submittals, including final letters, may be emailed (preferred) or faxed. We will also be shifting to a paperless fax receipt mode.

Special Inspection Services 1660 Mission Street - San Francisco CA 94103 Office (415) 558-6132 - FAX (415) 558-6474 - www.sfdbi.org

SPECIAL INSPECTION AND STRUCTURAL OBSERVATION A COPY OF THIS DOCUMENT SHALL BE KEPT WITH THE APPROVED STRUCTURAL DRAWING SET

JOB ADDRESS 17TH STREET BETWEEN VERMONT STREET APPLICATIO)N NO	_ ADDENDUM NO
OWNER NAME	OWNER PHONE NO. ()
Employment of Special Inspection is the direct responsibility as the owner's representative. Special inspection shall be conspector shall be furnished to DBI District Inspector prior to required. Structural observation shall be performed as proverecommended for owner/builder or designer/builder projects new processes or materials.	one of those as prescribed in Sec. 17 start of the work for which the Spec vided by Section 1704.6. A preconst	704. Name of special cial Inspection is truction conference is

In accordance with Chapter 17 (SFBC), Special Inspection and/or testing is required for the following work:

	,, ,	
 [] Concrete (Placement & sampling) [X] Bolts installed in concrete [] Special moment - resisting concrete frame [] Reinforcing steel and prestressing tendons Structural welding: A. Periodic visual inspection [X] Single pass fillet welds 5/16" or smaller [] Steel deck [] Welded studs [] Cold formed studs and joists [] Stair and railing systems [] Reinforcing Steel B. Continuous visual inspection and NDT (Section 1704) [] All other welding (NDT exception: Fillet weld) [] Reinforcing steel; and [] NDT required [] Moment-resisting frames [] Others 	6. [] High-strength bolting 7. [] Structural masonry 8. [] Reinforced gypsum concrete 9. [] Insulating concrete fill 10. [] Spray-on fireproofing 11. [] Piling, drilled piers and caissons 12. [] Shotcrete 13. [] Special grading, excavation and filling (Geo. Engineered) 14. [] Smoke-control system 15. [] Demolition 16. [] Exterior Facing 17. Retrofit of unreinforced masonry buil [] Testing of mortar quality and shear [] Inspection of repointing operations [] Installation inspection of new shear [] Pre-installation inspection for ember [] Pull/torque test per SFBC Sec.1607	tests (Section 1705.21) 23. [] Others: "As recommended by professional of bolts record"
24. Structural observation per Sec. 1704.6 for th [] Concrete construction [] [] Other: 25. Certification is required for: [] Glu-lam composite prepared by: EUGENE TUAN, TUAN AND ROBIN Engineer/Architect of Record	Masonry construction [] Wood onents	
Required information: FAX: <u>(415</u>) 957-2483	Email:_ETUAN@TRSE	EINC.COM
Review by:		none: <u>(</u>)
APPROVAL (Based on submitted reports.)	**********	
DATE DBI	Engineer or Plan Checker / Special Inspec	ction Services Staff
QUESTIONS ABOUT SPECIAL INSPECTION AN Special Inspection Services (415) 558-6132; or, d		

REVISIONS BY:

Bers, Inc.
101
a 94105
X 415 957 2483
ment of Professional Service not to be used, in whole or 17 2022

Tuan & Robin Structural Engineer 444 Spear Street, Suite 16 San Francisco, California 9 TEL 415 957 2480 FAX 4



POTRERO GATEWAY ARTWORK
17TH STREET BETWEEN VERMONT STR
AND SAN BRUNO AVENUE

General notes


DATE 06/10/2022 SCALE NONE DRAWN JC CHECKED ET

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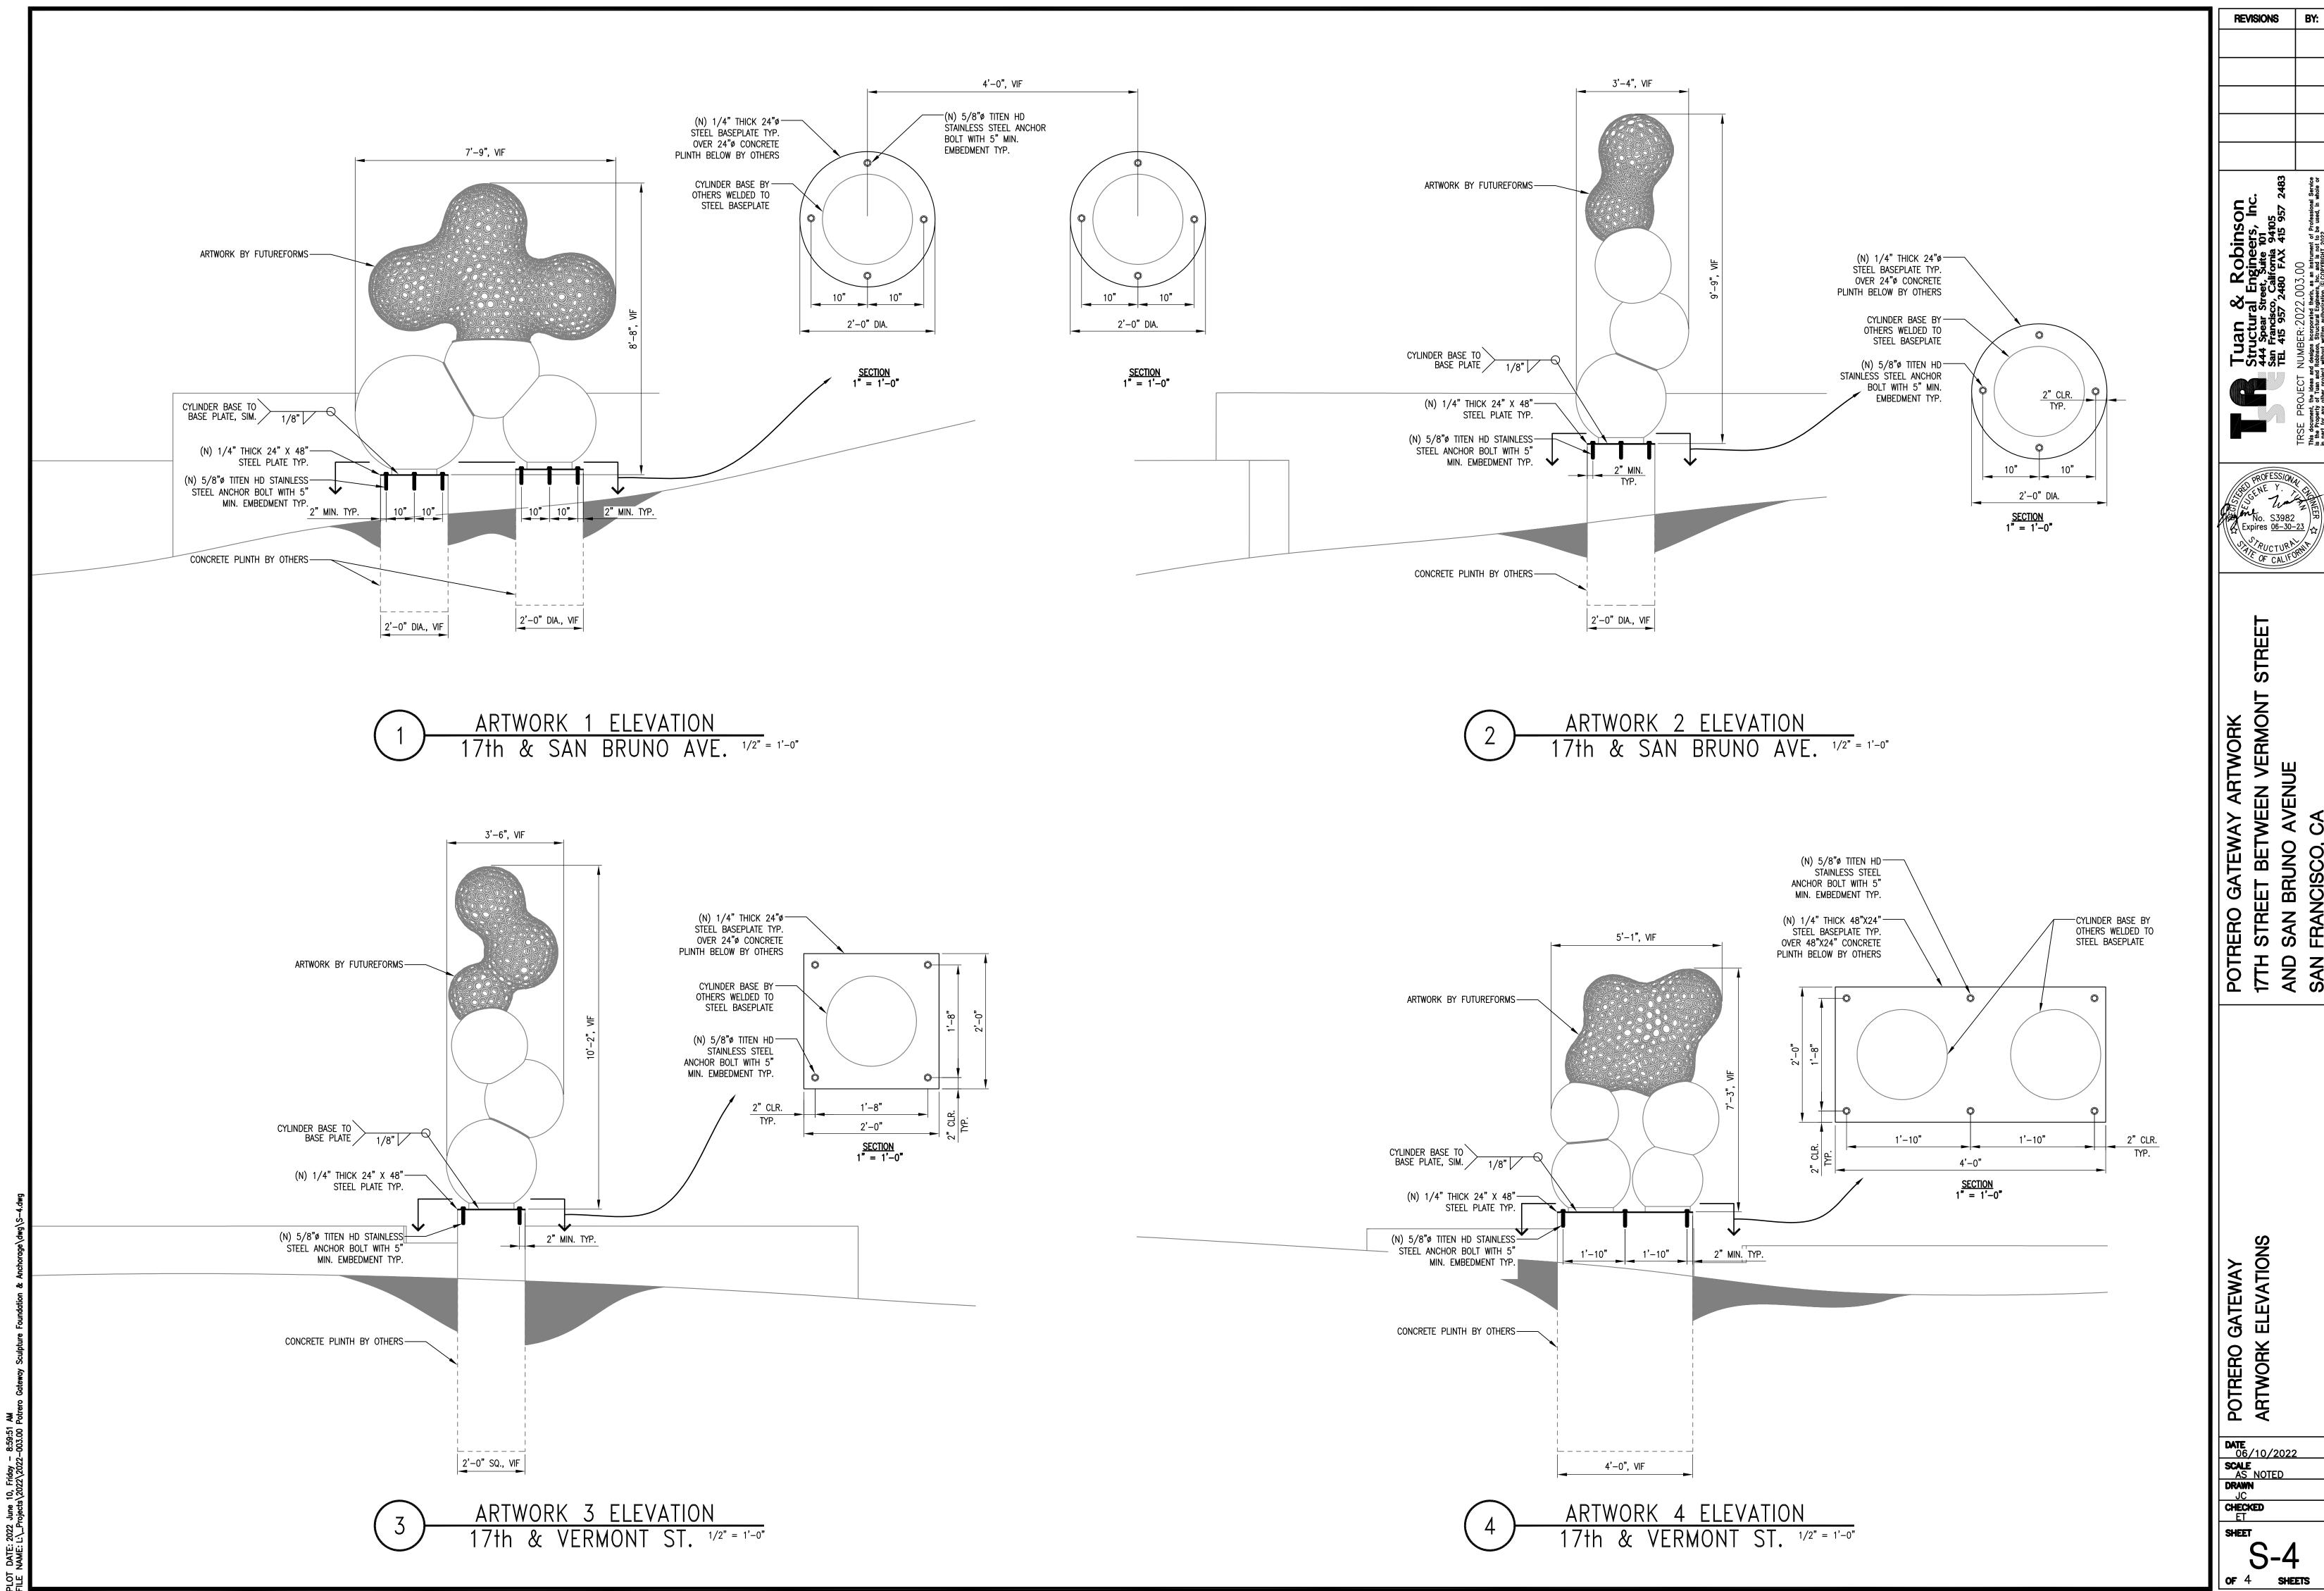
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OF 4 SHEETS





24" x 36" SHEET SIZE. IF SHEET IS SMALLER, THEN DRAWING HAS BEEN REDUCED.

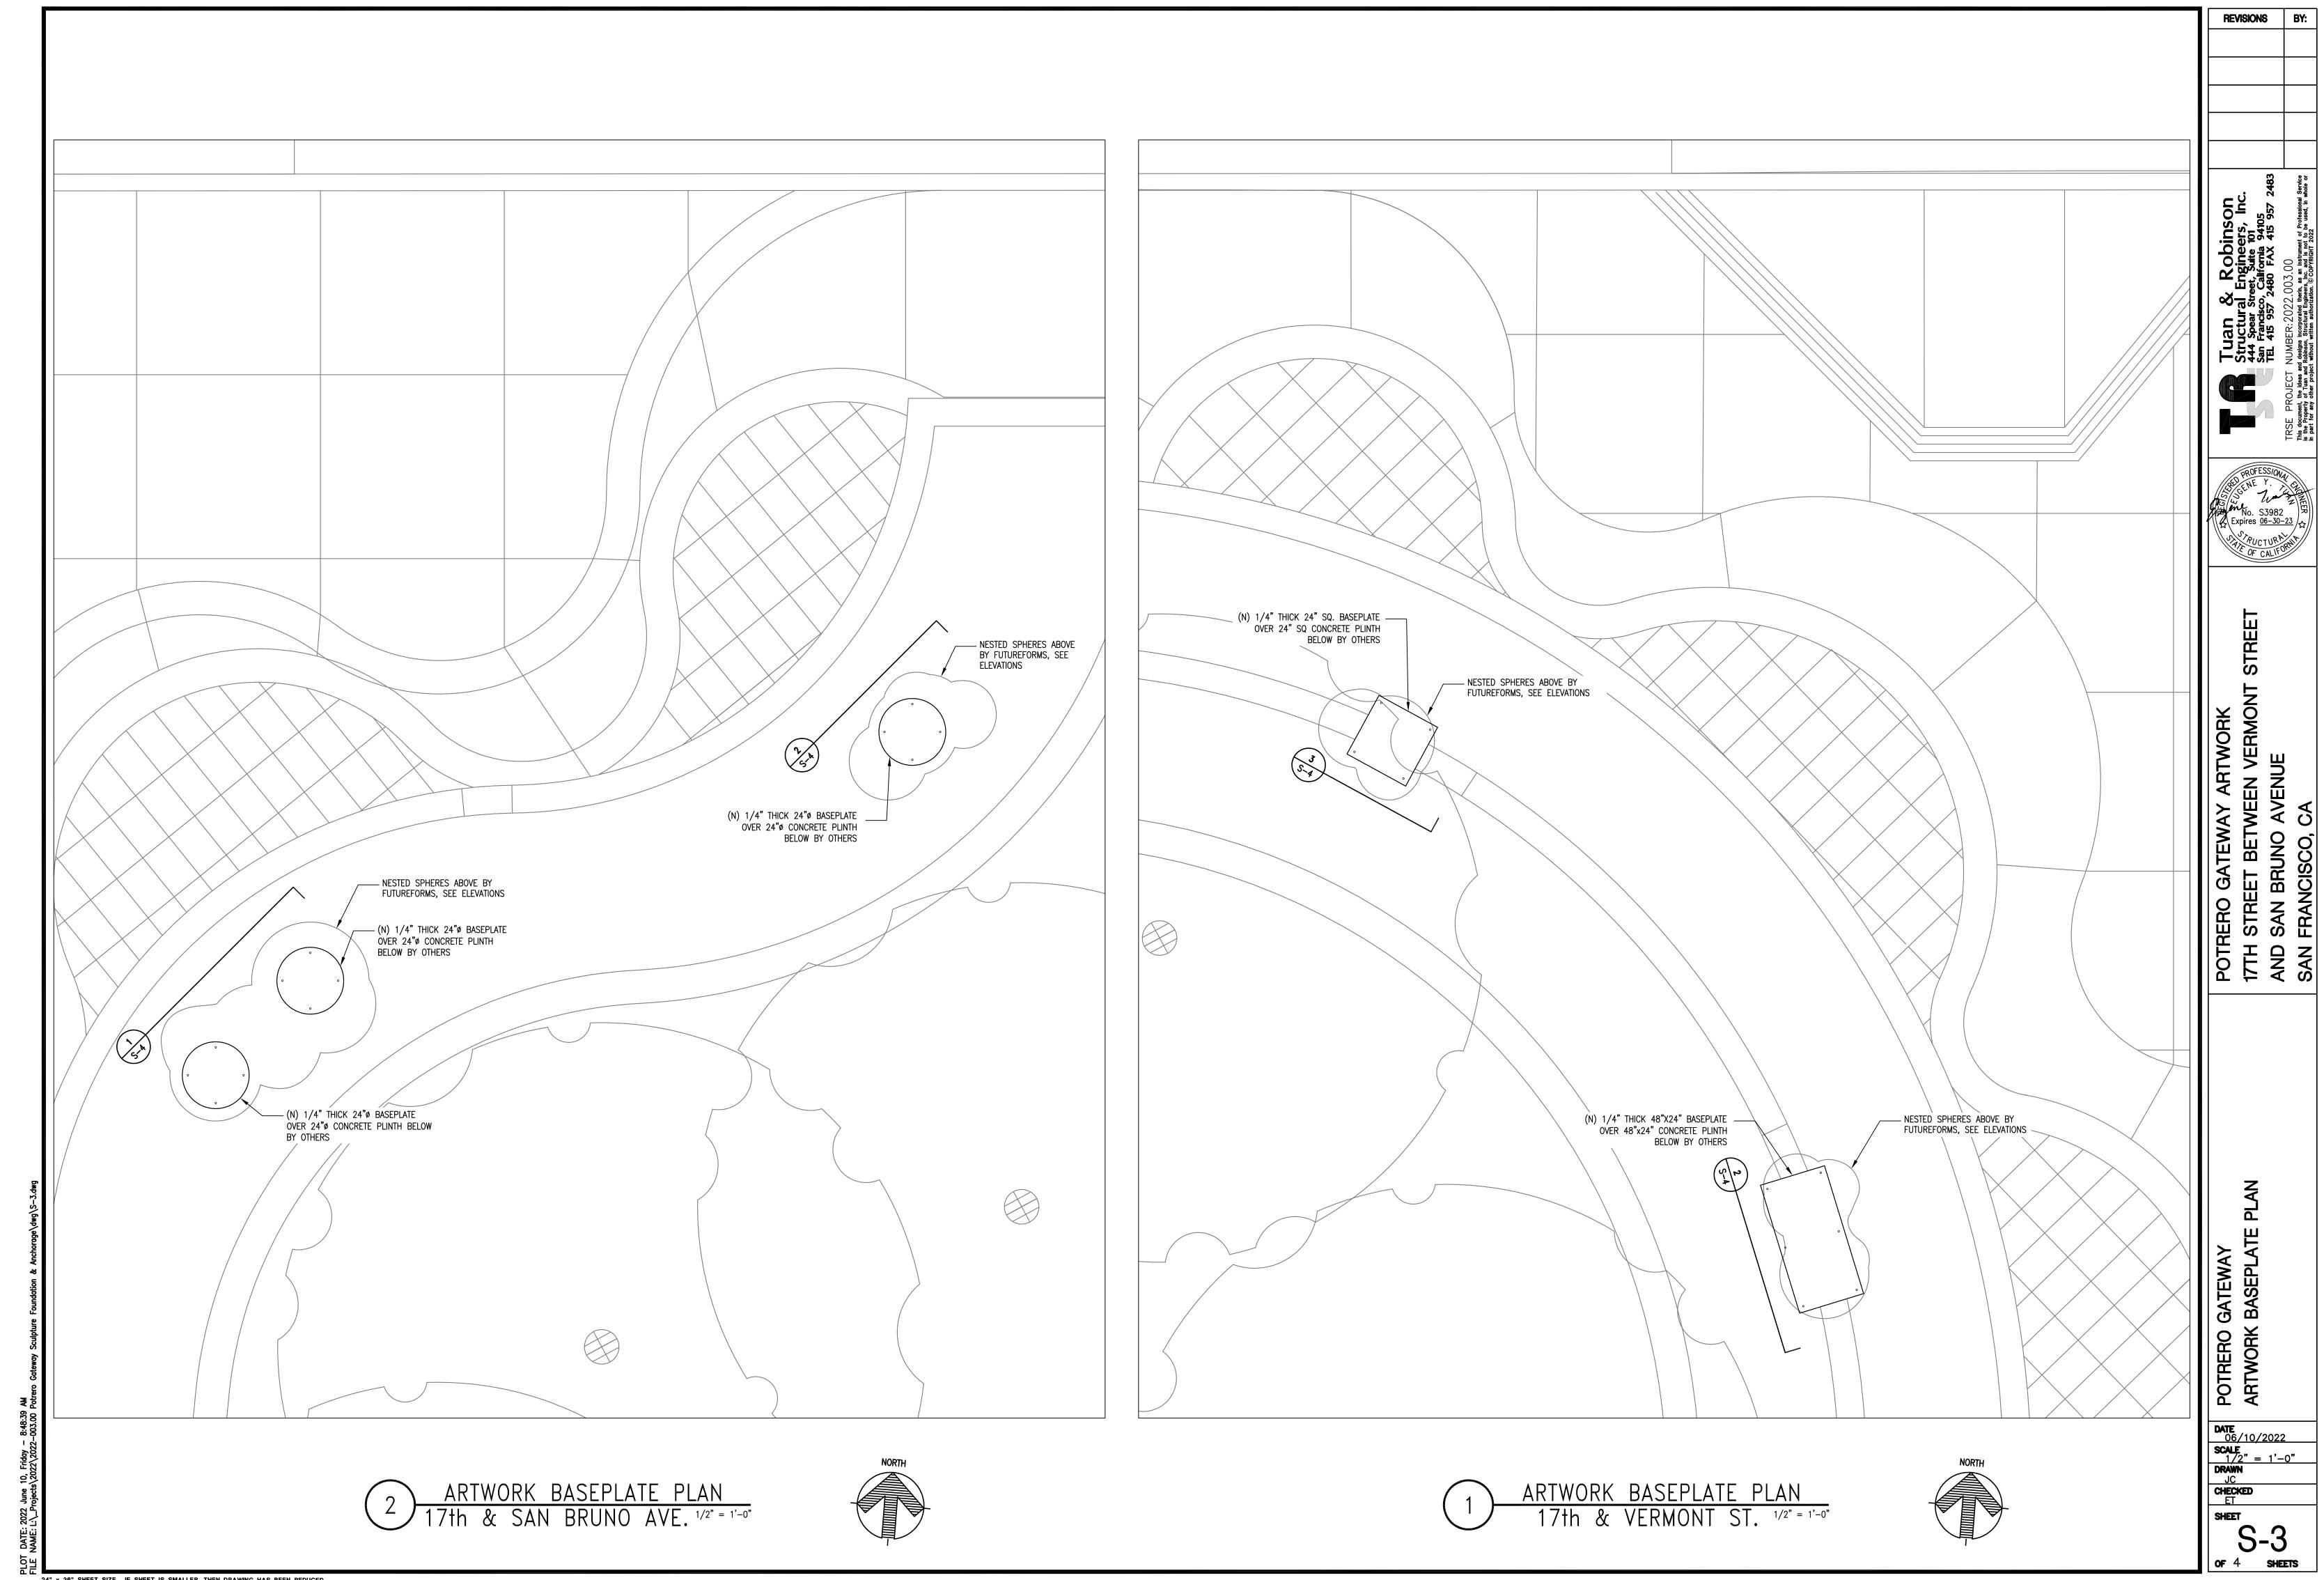

POTRERO 17TH STREI AND SAN E SAN FRANG

24" x 36" SHEET SIZE. IF SHEET IS SMALLER, THEN DRAWING HAS BEEN REDUCED.