

APPLICABLE CODES

2022 CALIFORNIA CODE OF REGULATIONS
 PART 2. 2022 CALIFORNIA BUILDING CODE, VOLUME 1 & 2
 PART 3. 2022 CALIFORNIA ELECTRICAL CODE
 PART 4. 2022 CALIFORNIA MECHANICAL CODE
 PART 5. 2022 CALIFORNIA PLUMBING CODE
 PART 6. 2022 CALIFORNIA ENERGY CODE
 PART 9. 2022 CALIFORNIA FIRE CODE
 PART 11. 2022 CALIFORNIA CALGREEN GREEN BUILDING STANDARDS

2023 SAN FRANCISCO ENVIRONMENT CODE
 AMERICANS WITH DISABILITIES ACT STANDARDS FOR DESIGN, 2010
 SAN FRANCISCO INTERNATIONAL AIRPORT BUILDING REGULATIONS, 2022

PROJECT INFORMATION:

LOCATION:
 SAN FRANCISCO INTERNATIONAL AIRPORT, WEST FIELD CAMPUS

PROJECT TYPE:
 NEW CONSTRUCTION

CONSTRUCTION TYPE:
 TYPE 2-B

OCCUPANCY GROUP:
 F-1

PROJECT GROSS AREA:
 3,727 SF

PROJECT DIRECTORY:

SPONSORING AGENCY AND OWNER:
 AIRPORT COMMISSION
 SAN FRANCISCO INTERNATIONAL AIRPORT
 CITY & COUNTY OF SAN FRANCISCO

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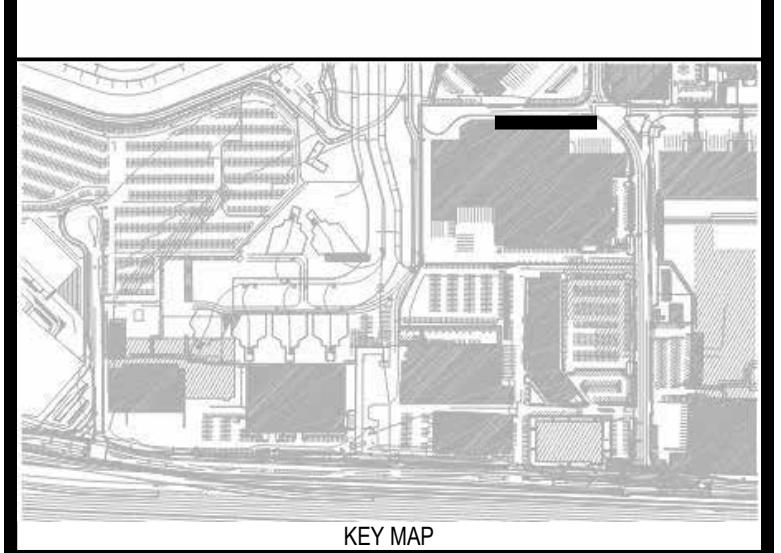
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A8.0.5	EXTERIOR DETAILS	01/26/2026
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GENERAL NOTES:

- CONTRACTOR SHALL OBTAIN ALL PERMITS AND INSPECTIONS AND COMPLY WITH ALL CODES, LAWS, ORDINANCES, RULES AND REGULATIONS OF ALL PUBLIC AUTHORITIES (FEDERAL, STATE, LOCAL, OR AIRPORT) GOVERNING THE WORK. NOTHING IN THESE PLANS AND SPECIFICATIONS SHALL BE CONSTRUED AS PERMITTING WORK NOT ACCORDING TO CODE.
- CONTRACTOR SHALL BE RESPONSIBLE FOR ALL FEES AND COSTS FOR LICENSES, PERMITS, SERVICE CHARGES, ETC., ASSESSED BY ANY GOVERNMENTAL AGENCY, EXCEPT THAT PRIMARY BUILDING PERMIT SHALL BE PROVIDED BY SFO.
- CONTRACTOR SHALL PERFORM NO PORTION OF THE WORK AT ANY TIME WITHOUT A PERMIT ISSUED BY REGULATORY AUTHORITY(IES).
- THE CONTRACTOR SHALL BE IN CHARGE OF THIS CONTRACT WITHIN THE LIMITS OF THE WORK AREA, AND SHALL DIRECT AND SCHEDULE THE WORK. FINAL RESPONSIBILITY FOR PERFORMANCE INTERFACE AND COMPLETION OF THE WORK AND THE PROJECT SHALL REST WITH THE CONTRACTOR.
- ALL WORK SHALL CONFORM TO THE CONTRACT DOCUMENTS WHICH INCLUDE THE CONTRACT, THE DRAWINGS, SPECIFICATIONS AND ALL ADDENDA AND MODIFICATIONS.
- THE CONTRACTOR SHALL PROVIDE ALL LABOR, MATERIALS, AND SERVICES NECESSARY FOR THE SATISFACTORY COMPLETION OF WORK SHOWN AND DESCRIBED IN THE CONTRACT DOCUMENTS.
- THE GENERAL CONTRACTOR SHALL COORDINATE AND BE RESPONSIBLE FOR THE WORK OF ALL SUB-CONTRACTORS, AND FOR COORDINATING WORK UNDER SEPARATE CONTRACT WITH THE OWNER.
- ALL CONTRACT DOCUMENTS, INCLUDING WITHOUT LIMITATION THESE NOTES AND SPECIFICATIONS, SHALL APPLY NOT ONLY TO THE GENERAL CONTRACTOR BUT TO ALL SUBCONTRACTORS AND SUPPLIERS ON THIS PROJECT. THE WORD "CONTRACTOR" SHALL HEREAFTER APPLY EQUALLY AND WITHOUT EXCEPTION TO ALL SUBCONTRACTORS AND SUPPLIERS. ALL CONTRACTORS ARE RESPONSIBLE FOR FAMILIARIZING THEMSELVES WITH THESE NOTES.
- ALL WORK NOTED "BY OTHERS" OR "N.I.C." SHALL BE PROVIDED BY OWNER OR UNDER SEPARATE CONTRACT. CONTRACTOR SHALL INCLUDE SCHEDULE REQUIREMENTS FOR THIS "OTHER" WORK IN CONSTRUCTION PROGRESS SCHEDULE AND COORDINATE AS REQUIRED TO ASSURE ORDERLY SEQUENCE OF INSTALLATION.
- SCHEDULE ALL WORK AND ORDER ALL MATERIALS TO PROCEED IN AN ORDERLY FASHION FROM BEGINNING TO COMPLETION. NOTIFY THE CONTRACT MANAGER WHEN ANY ITEM OR EQUIPMENT NECESSARY TO COMPLETE THE JOB IS UNAVAILABLE FOR COMPLETION TIME, IN ORDER TO CONSIDER AN ADEQUATE SUBSTITUTE.
- COORDINATE THE TRADES, CRAFTS, AND SUBCONTRACTORS AS REQUIRED TO PROVIDE CORRECT AND ACCURATE CONNECTION OF ABUTTING, ADJOINING, OVERLAPPING AND RELATED WORK. PROVIDE ANCHORS, FASTENERS, ACCESSORIES, APPURTENANCES, CAULKING AND SEALING, AND INCIDENTAL ITEMS AS REQUIRED TO COMPLETE THE WORK PROPERLY, FULLY, AND CORRECTLY IN ACCORDANCE WITH THE CONTRACT DOCUMENTS.
- THE CONTRACTOR SHALL NOTIFY THE CONTRACT MANAGER IMMEDIATELY OF ANY AND ALL UTILITIES DETERMINED IN THE COURSE OF CONSTRUCTION AS BEING NECESSARY TO BE REMOVED WHICH HAVE NOT OTHERWISE BEEN NOTED FOR REMOVAL IN THE CONSTRUCTION DOCUMENTS. THE CONTRACTOR SHALL REMOVE SAID UTILITIES ONLY AFTER CONSULTATION WITH, APPROVAL OF AND COORDINATION BY THE CONTRACT MANAGER.
- THE CONTRACTOR SHALL PROTECT WORK AREA AND ALL ADJACENT AREAS FROM ANY DAMAGE WHICH OCCURS BECAUSE OF THIS WORK. ANY BUILDING OR SITE AREAS AND COMPONENTS UNAFFECTIONED BY THIS WORK SHALL BE PROTECTED FROM ANY DAMAGE CAUSED BY THIS WORK. ANY DAMAGE TO EXISTING STRUCTURES AND PHYSICAL PLANT THAT DOES OCCUR SHALL BE THE FINANCIAL RESPONSIBILITY OF THE CONTRACTOR.
- ALL MATERIALS OR INSTALLATIONS TO BE PART OF THE CONTRACT SHALL BE PROTECTED FROM DAMAGE DURING CONSTRUCTION AND, IF DAMAGED, SHALL BE REPLACED TO THE CONTRACT MANAGER'S SATISFACTION BEFORE THE FINAL ACCEPTANCE.
- THE CONTRACTOR SHALL INSTALL WORK PLUMB, LEVEL, SQUARE, TRUE AND IN PROPER ALIGNMENT, WORK SHALL BE PERFORMED IN A WORKMANLIKE AND WELL CRAFTED MANNER.
- THE CONTRACTOR SHALL PROVIDE PUBLIC PROTECTION AS NECESSARY PER OWNER'S REQUIREMENTS AS APPROVED BY CONTRACT MANAGER. THE CONTRACTOR SHALL BE RESPONSIBLE FOR INSTALLING ALL TEMPORARY SHORING AND BRACING TO INSURE THE SAFETY OF THE WORK.
- THE CONTRACTOR SHALL MAINTAIN FOR THE ENTIRE DURATION OF THE WORK ALL EXITS, EXIT LIGHTING, FIRE PROTECTION DEVICES AND ALARMS IN CONFORMANCE WITH ALL APPLICABLE CODES AND ORDINANCES.
- THE CONTRACTOR SHALL REMOVE CONSTRUCTION DEBRIS, UNUSED MATERIALS, ETC., FROM THE JOB SITE ON A REGULAR BASIS AND SHALL KEEP THE JOB SITE CLEAN AND ORDERLY AT ALL TIMES, AND SHALL REVIEW WITH THE CONTRACT MANAGER HOW DEBRIS IS TO BE REMOVED FROM THE SITE, PRIOR TO BEGINNING WORK.
- HIDDEN CONDITIONS UNCOVERED ONCE THE WORK HAS BEGUN SHALL BE PROMPTLY BROUGHT TO THE ATTENTION OF THE CONTRACT MANAGER FOR DETERMINATION OF ANY NECESSARY ACTION OR CHANGES TO THE WORK.
- CONTRACTOR SHALL CLOSELY FOLLOW THE DIMENSIONS AND RELATIONSHIPS NOTED ON THE DRAWINGS, AND SHALL PROVIDE PRODUCTS AND WORKMANSHIP APPROPRIATE TO A FINISHED ARCHITECTURAL INSTALLATION.
- ALL LINES, SYMBOLS, NOTES AND OTHER GRAPHIC DEVICES CONTAINED IN THE CONTRACT DOCUMENTS CARRY SPECIFIC OR INFERENTIAL MEANING. ITEMS INDICATED IN THESE WAYS ARE A PART OF THE SCOPE OF WORK AND WILL BE REQUIRED BY THE CONTRACT MANAGER TO BE INCLUDED IN THE SCOPE OF THE CONTRACTOR'S WORK WHETHER THEY HAVE BEEN INCLUDED IN THE CONTRACTOR'S ORIGINAL BID OR NOT. ANY ITEMS WHICH REQUIRE FURTHER CLARIFICATION BY THE CONTRACT MANAGER FOR THE SPECIFIC BENEFIT OF THE CONTRACT SHALL BE BROUGHT TO THE ATTENTION OF THE CONTRACT MANAGER FOR SUCH CLARIFICATION BEFORE COMMENCEMENT OF ANY WORK.
- NOTES ARE AN AID TO THE CONTRACTOR IN UNDERSTANDING THE WORK AND SHOULD NOT BE CONSTRUED AS BEING COMPLETE IN EVERY DETAIL. THE CONTRACTOR SHALL REVIEW ALL WORK IS BUILDABLE AS SHOWN. IT IS THE EXPLICIT AND SPECIFIC RESPONSIBILITY OF THE CONTRACTOR TO VISIT THE SITE, VERIFY THE EXISTING CONDITIONS, BECOME THOROUGHLY FAMILIAR WITH THE SCOPE OF WORK, AND REPORT ALL DISCREPANCIES, CONFLICTS, OMISSIONS, ETC., BETWEEN THE DRAWINGS AND THE ASSUMED OR ACTUAL CONDITIONS TO THE CONTRACT MANAGER PRIOR TO THE PERFORMANCE OF ANY WORK.
- NO ONE DRAWING OR NOTE SHALL "GOVERN". CONTRACTOR SHALL CORRELATE WORK BETWEEN DRAWINGS OF DIFFERENT SCALES WITHIN EACH SECTION. IT IS THE EXPLICIT AND SPECIFIC RESPONSIBILITY OF THE CONTRACTOR TO EXAMINE THE CONTRACT DOCUMENTS IN THEIR ENTIRETY, REPORT ALL DISCREPANCIES ENCOUNTERED THEREIN TO THE ATTENTION OF THE CONTRACT MANAGER AND AWAIT RESOLUTION BEFORE PROCEEDING WITH ANY WORK AFFECTED BY SUCH DISCREPANCIES. WHERE THE REQUIREMENTS GIVEN IN THE NOTES OR THE DRAWINGS ARE AT VARIANCE, THE MORE RESTRICTIVE PROVISION SHALL GOVERN.
- ALL HEIGHTS ARE DIMENSIONED ABOVE FINISH FLOOR (AFF) OR FROM A DESIGN DATUM, UNLESS OTHERWISE NOTED.
- DIMENSIONS MARKED "VERIFY" ARE TO BE CHECKED FOR ACCURACY BY THE CONTRACTOR AS WORK PROGRESSES, AND ANY DISCREPANCIES ARE TO BE BROUGHT TO THE ATTENTION OF THE CONTRACT MANAGER BEFORE PROCEEDING.
- ALL REVISIONS TO THE DRAWINGS MUST PROCEED THROUGH THE CONTRACT MANAGER.
- IT IS THE RESPONSIBILITY OF THE CONTRACTOR TO CO-ORDINATE, REQUEST AND FORWARD TO THE CONTRACT MANAGER FOR REVIEW: SHOP DRAWINGS, PRODUCT DATA, SAMPLES AND SIMILAR SUBMITTALS REQUIRED BY THE CONTRACT DOCUMENTS IN SUCH SEQUENCE AS TO CAUSE NO DELAY IN THE WORK OR IN THE ACTIVITIES OR THE AIRPORT OR OF SEPARATE CONTRACTORS.
- OBTAIN FIELD MEASUREMENTS REQUIRED FOR THE ACCURATE FABRICATION AND INSTALLATION OF THE WORK INCLUDED IN THIS CONTRACT. FIELD VERIFY DIMENSIONS INDICATED IN THE CONTRACT DOCUMENTS. EXACT MEASUREMENTS ARE THE CONTRACTOR'S RESPONSIBILITY.
- ANY OMISSIONS OR CONTRADICTIONS IN THESE DOCUMENTS SHALL BE CALLED TO THE ATTENTION OF THE CONTRACT MANAGER PRIOR TO BID OPENING. BIDS RECEIVED SHALL BE CONSIDERED TO INCLUDE ALL ITEMS FOR A COMPLETE PROJECT.
- WRITTEN DIMENSIONS ON THESE DRAWINGS SHALL HAVE PRECEDENCE OVER SCALED DIMENSIONS. CONTRACTORS SHALL VERIFY AND BE RESPONSIBLE FOR ALL DIMENSIONS AND CONDITIONS ON THE JOB AND THE CONTRACT MANAGER SHALL BE NOTIFIED OF ANY VARIATIONS AND CONDITIONS SHOWN BY THESE DRAWINGS.
- IN THE EVENT THAT CERTAIN DETAILS OF THE CONSTRUCTION ARE NOT FULLY SHOWN OR NOTED IN THESE DRAWINGS OR CALLED FOR IN THE SPECIFICATIONS, THEIR CONSTRUCTION SHALL BE OF THE SAME CHARACTER AND SIZE AS FOR SIMILAR CONDITIONS SHOWN HEREIN.
- IN CASE OF CONFLICT BETWEEN ANY REFERENCED STANDARDS, OR BETWEEN THE DRAWINGS AND SPECIFICATIONS, THE DOCUMENT HAVING THE MORE STRINGENT REQUIREMENT SHALL GOVERN.
- POWDER-DRIVEN FASTENERS SHALL NOT BE USED FOR ANY VERTICALLY HUNG CONSTRUCTION, ANY BRACING, OR ANY OTHER SIMILAR APPLICATIONS. THESE APPLICATIONS SHALL BE DONE BY PREDRILLING AND ANCHORING WITH EXPANSION ANCHOR BOLTS REGARDLESS OF VERTICAL OR HORIZONTAL APPLICATIONS. OTHER FASTENING SHALL BE DONE BY NAILING, SCREWING, OR RIVETING, ETC.
- ALL PLYWOOD UNDERLAYMENT SHALL BE FIRE RETARDANT TREATED, TYPICAL.
- ARCHITECT BASED DRAWINGS ON PREVIOUS CONSTRUCTION DOCUMENTS OF AREA, ALL DIMENSIONS SHOWN ARE TO BE VERIFIED IN FIELD PRIOR TO ORDER OF FINISHES, FIXTURES, OR OTHER INSTALLED MATERIALS.
- DRAWINGS OF AN EXISTING CONSTRUCTION ARE INTENDED TO BE AN AID TO CONSTRUCTION AND CANNOT BE ASSUMED TO BE ACCURATE IN DETAIL. CONTRACTOR SHALL CHECK AND VERIFY ALL DIMENSIONS, ELEVATIONS AND CONDITIONS AT THE SITE BEFORE COMMENCEMENT OF WORK AND NOTIFY THE ARCHITECT IN WRITING OF ANY DISCREPANCIES IN PLANS AND SPECIFICATIONS BEFORE PROCEEDING.
- THE DOCUMENTS DESCRIBE DESIGN INTENT. CONTRACTOR IS RESPONSIBLE TO PROVIDE COMPLETE, OPERATIONAL SYSTEMS AND INSTALLATIONS. NO CLAIMS FOR ADDITIONAL WORK WILL BE AWARDED FOR WORK WHICH IS DESCRIBED IN THESE DOCUMENTS OR WHICH IS REASONABLY INFERRABLE FROM THEM.
- ALL DIMENSIONS, NOTES AND DETAILS SHOWN ON A PORTION OF A DRAWING SHALL APPLY TYPICALLY TO ALL OPPOSITE HAND AND/OR SIMILAR CONDITIONS, U.O.N.
- CONTRACTOR IS RESPONSIBLE FOR THE THOROUGH COORDINATION OF ALL TRADES. NO CLAIMS FOR ADDITIONAL WORK WILL BE AWARDED FOR WORK RELATED TO SUCH COORDINATION.



REVISIONS	DESCRIPTION
NO	DATE

NO	DATE	DESCRIPTION
1	01/26/2026	Initial Submission


CONTRACT NO.	PROJECT TITLE	SHEET TITLE	CONSULTANT'S LOGO
11921.66	WEST FIELD UTILITIES AND PAVING	- STATION BP	PTA

DESIGNED BY:	CHECKED BY:
JT	JT
DRAWN BY:	DATE:
JT	01/26/2026
SCALE:	SIZE:
AS NOTED	ARCH-D
SHEET NUMBER	11921.66
REVISION	

AO.0.1


ABBREVIATIONS:

&	AND	(E.)	EXISTING	HDWE.	hardware	OPER.	OPERABLE	S.N.R.	SANITARY NAPKIN
@	AT	E.	EAST	HGT.	HEIGHT	OPNG.	OPENING	RECEPTACLE	
A.B.	ANCHOR BOLT	EA.	EACH	H.H.	HEAD HEIGHT	OPP.	OPPOSITE	S.P.D.	SEE PLUMBING DWGS.
AB./ABV.	ABOVE	E.F.	EXHAUST FAN	H.M.	HOLLOW METAL	O/.	OVER	SPEC.	SPECIFICATION
A.C.	AIR CONDITIONING	E.J.	EXPANSION JOINT	HORIZ.	HORIZONTAL	P.	POLE	SQ.	SQUARE
ACOUS.	ACOUSTICAL	EL.	ELEVATION	H.R.	HAND RAIL	PAV.	PAVING	S.S.D.	SEE STRUCTURAL DWGS.
A.D.	AREA DRAIN	ELEC.	ELECTRICAL	HR.	HOUR	PERF.	PERFORATED	S.S.K.	SERVICE SINK
ADJ.	ADJUSTABLE	ELEV.	ELEVATOR	H.W.	HOT WATER	PERP.	PERPENDICULAR	S.S/T.S.S.	STAINLESS STEEL
A.F.F.	ABOVE FINISH FLOOR	EMER.	EMERGENCY	I.D.	INSIDE DIAMETER(DIM.)	PL.	PLATE	STA.	STATION
AGGR.	AGGREGATE	ENCL.	ENCLOSURE	IDF	INTERMEDIATE DISTRIBUTION	PLAM.	PLASTIC LAMINATE	STL.	STEEL
A.H.A.P.	AS HIGH AS POSSIBLE	ENG.	ENGINEER	END OF	FRAME	PLAS.	PLASTER	STD.	STANDARD
A.H.U.	AIR HANDLING UNIT	E.O.		(ELECTRICAL CLOSET)	INSUL.	PLYWD.	PLYWOOD	STOR.	STORAGE
ALUM.	ALUMINUM	E.O.S.	EDGE OF SLAB	INT.	INSULATION	P.O.B.	POINT OF BEGINNING	STRL.	STRUCTURAL
ALT.	ALTERNATE	E.P.	ELECTRICAL	JAN.	INTERIOR	PR.	PAIR	SUSP.	SUSPENDED
A.P.	ACOUSTICAL PANEL		PANELBOARD	JT.	JANITOR	PRCST.	PRECAST	T.	TILE, TREAD OR TOP
APPROX.	APPROXIMATE	EQ.	EQUAL	INV.	JOINT	PROP.	PROPERTY	T.B.	TOWEL BAR
ARCH.	ARCHITECT	EQPT.	EQUIPMENT	PRCST.	KITCHEN	PT.	PAINT	T.C.	TOP OF CURB
ARCHL.	ARCHITECTURAL	ERRCS	EMERGENCY	PTD./PNT.		P.T.	PRESSURE TREATED	TEL.	TELEPHONE
ASB.	ASBESTOS		RESPONDER	PTD./PNT.		PTD.	PAINTED	TEMP.	TEMPERED
ASPH.	ASPHALT		RADIO COVERAGE	PT.DIR.		P.T.D.	PAPER TOWEL DISPENSER	TER.	TERRAZZO
AXON.	AXONOMETRIC		SYSTEM	PT.DIR.		DISPENSER/RECEPACLE	COMBINATION PAPER TOWEL	T.G.	TONGUE AND GROOVE
B.	BATHROOM	E.S.	EACH SIDE	PTN.		PTN.	DISPENSER/RECEPACLE	THK.	THICK
B.B.	BULLETIN BOX	E.W.C.	ELECTRICAL WATER HEATER	LA.	LAYER	PTN.	PARTITION	THRU.	THROUGH
B.B.C.	BB.C. BARBECUE	EXIST.	EXISTING	LAM.	LAMINATE	P.T.R.	PAPER TOWEL RECEPACLE	TN.	TOENAIL
B.C.	BOTTOM OF CURB	EXP.	EXPANSION	LAV.	LAVATORY	Q.T.	QUARRY TILE	T.O.	TOP OF
BD.	BOARD	EXPO.	EXPOSED	LBS.	POUNDS	Q.TY.	QUANTITY	T.P.	TOP OF PAVEMENT
BITUM.	BITUMINOUS	EXT.	EXTERIOR	LKR.	LOCKER	REINFORCED CONCRETE	T.P.D.	TOILET PAPER DISPENSER	
BLDG.	BUILDING	EXTR.	EXTRUSION	LOC.	LOCATION	REFL.	REFRIGERATOR	T.P.S.	TRANSLUCENT PANEL
BLK.	BLOCKING/BLOCK	F.A.	FIRE ALARM	LOSP.	LOCAL OPERATING SUBSIDY	RAD.	RISER	SYSTEM	
BLW.	BELOW	F.A.U.	FORCED AIR UNIT	PROGRAM		R.C.	ROOF DRAIN	T.V.	TELEVISION
BM.	BEAM	F.B.	FLAT BAR	LOW.LEV.	LOWER LEVEL	REF.	RESILIENT CHANNEL /	T.W./T.O.W.	TOP OF WALL
B.O.	BOTTOM OF	F.D.	FLOOR DRAIN	LR.	LIVING ROOM	REFL.	RESILIENT	TOP.	
BOT.	BOTTOM	F.D.C.	FIRE DEPARTMENT	LT.	LIGHT	REV.	REVISION	TYP.	TYPICAL
BR.	BEDROOM	F.E.	CONNECTION	MACH.	MACHINE	R.C.P.	REFLECTED CEILING PLAN	UNF.	UNFINISHED
B.U.	BUILT UP	F.E.	FIRE EXTINGUISHER	MAG.	MAGNETIC	R.D.	REFLECTED CEILING PLAN	U.O.N.	UNLESS OTHERWISE NOTED
CAB.	CABINET	F.E.C.	(SURFACE)	MANUF.	MANUFACTURER	REF.	REFERENCE	UP.LEV.	UPPER LEVEL
CARP.	CARPET	F.C.O.	FLOOR CLEAN OUT	LIT.	LITERATURE	RGTR.	REGISTER	UR.	URINAL
C.B.	CATCH BASIN	F.F.	FINISH FLOOR	MATL.	MATERIAL	REINF.	REINFORCED	UTIL.	UTILITY
CEM.	CEMENT	F.G.	FINISH GLASS	MAX.	MAXIMUM	REQ.	REQUIRED	V.B.	VERTICAL BLIND
CER.	CERAMIC	F.H.	FIRE HOSE	M.B.	MACHINE BOLT	RESIL.	RESILIENT	V.C.T.	VINYL COMPOSITION TILE
CHAN.	CHANNEL	F.H.W.B.	FLAT HEAD MACHINE BOLT	MBL.	MARBLE	REV.	REVISION	VENT.	VENTILATION
C.H.	CEILING HEIGHT	F.H.M.S.	FLAT HEAD MACHINE SCREW	M.C.	MEDICINE CABINET	RH.	ROW HOUSE	VER.	VERIFY
C.I.	CAST IRON	F.H.W.S.	FLAT HEAD WOOD SCREW	M.D.F.	MEDIUM DENSITY FIBERBOARD	R.M.	ROOM	VERT.	VERTICAL
C.J.	CONTROL JOINT	FIN.	FINISH	M.D.O.	MEDIUM DENSITY	R.O.	ROUGH OPENING	VEST.	VESTIBULE
C.L.	CENTER LINE	FIXT.	FIXTURE	OVERLAY(BOARD)	OVERLAY(BOARD)	RWD.	REDWOOD	V.G.D.F.	VERTICAL GRAIN DOUGLAS FIR
C.G.	CORNER GUARD	FL/FLR.	FLOOR	MECH.	MECHANICAL	R.W.L.	RAIN WATER LEADER	V.I.F.	VERIFY IN FIELD
CL.G.	CEILING	FLASH.	FLASHING	MEMB.	MEMBRANE	S.	SOUTH	VS.	VINYL SHEET
CLKG.	CAULKING	FLOUR.	FLUORESCENT	MET.	METAL	S.A.D.	SEE ARCHITECTURAL	W.	WEST
CLOS.	CLOSET	FND.	FOUNDATION	MFR.	MANUFACTURER	SCHED.	SEE CIVIL DRAWINGS	W.I.	WITH
CLR.	CLEAR	F.O.	FACE OF	MH.	MANHOLE	SCHED.	SCHEDULE	W.B.	WHITE BOARD
COL.	COLUMN	F.O.C.	FACE OF CONCRETE WALL	MIN.	MINIMUM	S.A.S.M.	SELF ADHERED SHEET	W.C.	WATER CLOSET
COMP.	COMPOSITION	F.O.F.	FACE OF FINISH	MIR.	MIRROR	MEMBRANE	SELF ADHERED SHEET	WD.	WOOD
CONC.	CONCRETE	F.O.S.	FACE OF STUDS	MISC.	MISCELLANEOUS	S.A.S.F.	SELF ADHERED SHEET	WDW.	WINDOW
CONN.	CONNECTION	FPRF.	FIREPROOF	M.O.	MASONRY OPENING	FLASHING	FLASHING	W.H.	WATER HEATER
CONSTR.	CONSTRUCTION	FRR.	FIRE RESISTANCE RATING	MPOE	'MINIMUM POINT OF ENTRY	S.C.	SOLID CORE	W.G.	WIRE GLASS
CONT.	CONTINUOUS	F.S.	FIRE SPRINKLER	(ELEC. ROOM)		S.C.D.	SEE CIVIL DRAWINGS	W.P.	WATERPROOF /
CORR.	CORRIDOR	F.S.D.	FIRE/SMOKE DAMPER	M.P.	MEASURING POINT	SCHED.	SEE CIVIL DRAWINGS	W.R.B.	WATER RESISTIVE BARRIER
cpt.	CARPET	FT.	FOOT OR FEET	M.R.	MOISTURE RESISTANT	SCHED.	SEE CIVIL DRAWINGS	W.S.P.	WET STAND PIPE
CMU.	CONCRETE MASONRY	FTG.	FOOTING	MTD.	MOUNDED	S.E.D.	SEE ELECTRICAL DWGS.	W.SCT.	WAISNCOT
UNIT		FR.	FRAME	MTL.	METAL	S.D.	SOAP DISPENSER	WT.	WEIGHT
CNTR.	COUNTER	FURR.	FURRING	MUL.	MULLION	SECT.	SECTION	W.O.	WHERE OCCURS
CTR.	CENTER	FUT.	FUTURE			S.F.	SUPPLY FAN	W/O.	WITHOUT
CTSK.	COUNTERSUNK	GA.	GAUGE	(N.)	NEW	S.I.D.	SEE INTERIOR DWGS.	WP.	WATERPROOF /
C.W.	COLD WATER	GALV.	GALVANIZED	N.	NORTH	S.H.	SILL HEIGHT	W.R.B.	WATERPROOFING
DBL.	DOUBLE	G.B.	GRAB BAR	N.A.	NOT ACCESSIBLE	SHR.	SHOWER	W.S.P.	WATER RESISTIVE BARRIER
DEPT.	DEPARTMENT	G.F.R.C.	GLASS FIBER REINFORCED	N.I.C.	NOT IN CONTRACT	SHT.	SHEET	W.SCT.	WET STAND PIPE
DET.	DETAIL		CONCRETE	NO. OR #	NUMBER	SHTG.	SHETING	WT.	WAISNCOT
D.F.	DRINKING FOUNTAIN	GL.	GLASS OR GRIDLINE	NOM.	NOMINAL	SIM.	SIMILAR	W.W.F.	WEIGHT
DIA.	DIAMETER	GND.	GROUND	N.T.S.	NOT TO SCALE	S.J.	SEISMIC JOINT	W.W.M.	WIRE WELDED FABRIC
DIM.	DIMENSION	GR.	GRADE	OA.	OVERALL	SL.	SLIDING	W.W.M.	WOVEN WIRE MESH
DISP.	DISPENSER	G.S.M.	GALVANIZED SHEET METAL	OB.	OBlique	S.F.P.D.	SEE FIRE PROTECTION DWGS.		
DN.	DOWN	GYP.	GYPSUM	OBS.	OBSCURE	S.L.D.	SEE LANDSCAPE DWGS.		
D.O.	DOOR OPENING	H.B.	HOSE BIBB	O.C.	ON CENTER	S.L.R.D.	SEE LIVING ROOF DWGS.		
DR.	DOOR	H.C.	HOLLOW CORE	OCC.	OCUR	S.M.D.	SEE MECHANICAL DWGS.		
DS.	DOWNSPOUT	HD.	HEAD	O.D.	OUTSIDE DIAMETER(DIM.)	S.M.M.D.	SEE METHANE MITIGATION		
D.S.P.	DRY STANDPIPE	HDR.	HEADER	OFF.	OFFICE	DWGS.	DWGS.		
DWG(S).	DRAWING(S)	HDWD.	HARDWOOD	OH.	OPPOSITE HAND	S.M.S.	SHEET METAL SCREW		
DWR.	DRAWER			OPT.	OPTIONAL	S.N.D.	SANITARY NAPKIN		
						DISPENSER			

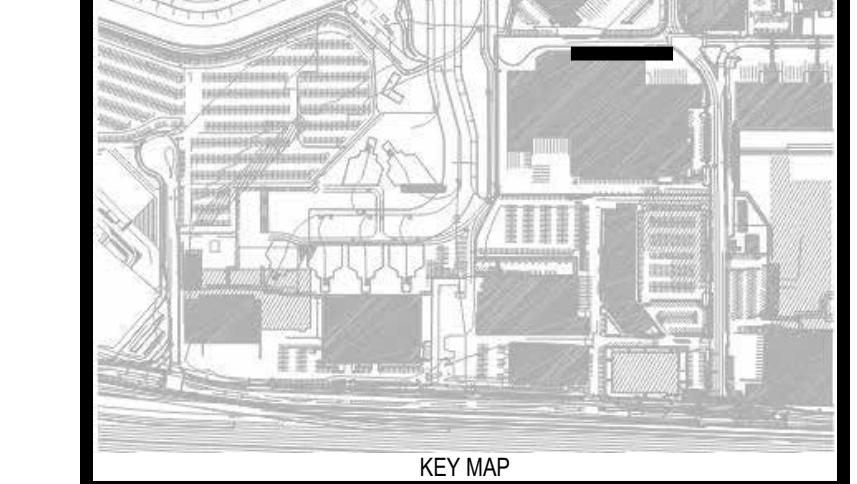

REVISIONS		DESCRIPTION	BY
NO	DATE		
11921.66		WEST FIELD UTILITIES AND PAVING	- STATION BP
CONTRACT NO.		PROJECT/TITLE	GENERAL NOTES
SHEET TITLE			
SEAL		CONSULTANT'S LOGO	
		PTA	

DESIGNED BY: JT	CHECKED BY: JT
DRAWN BY: JT	DATE: 01/26/2026
SCALE: AS NOTED	SIZE: ARCH-D
SHEET NUMBER	
AO.0.2	
REVISION	
OF	

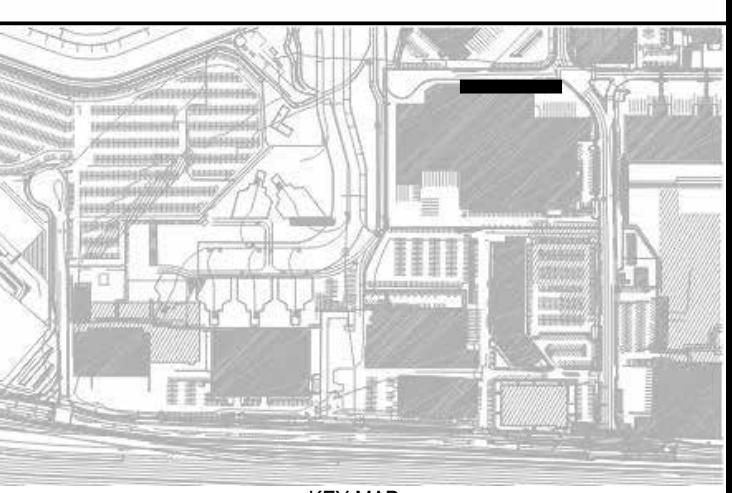

REVISIONS	NO. / DATE	DESCRIPTION
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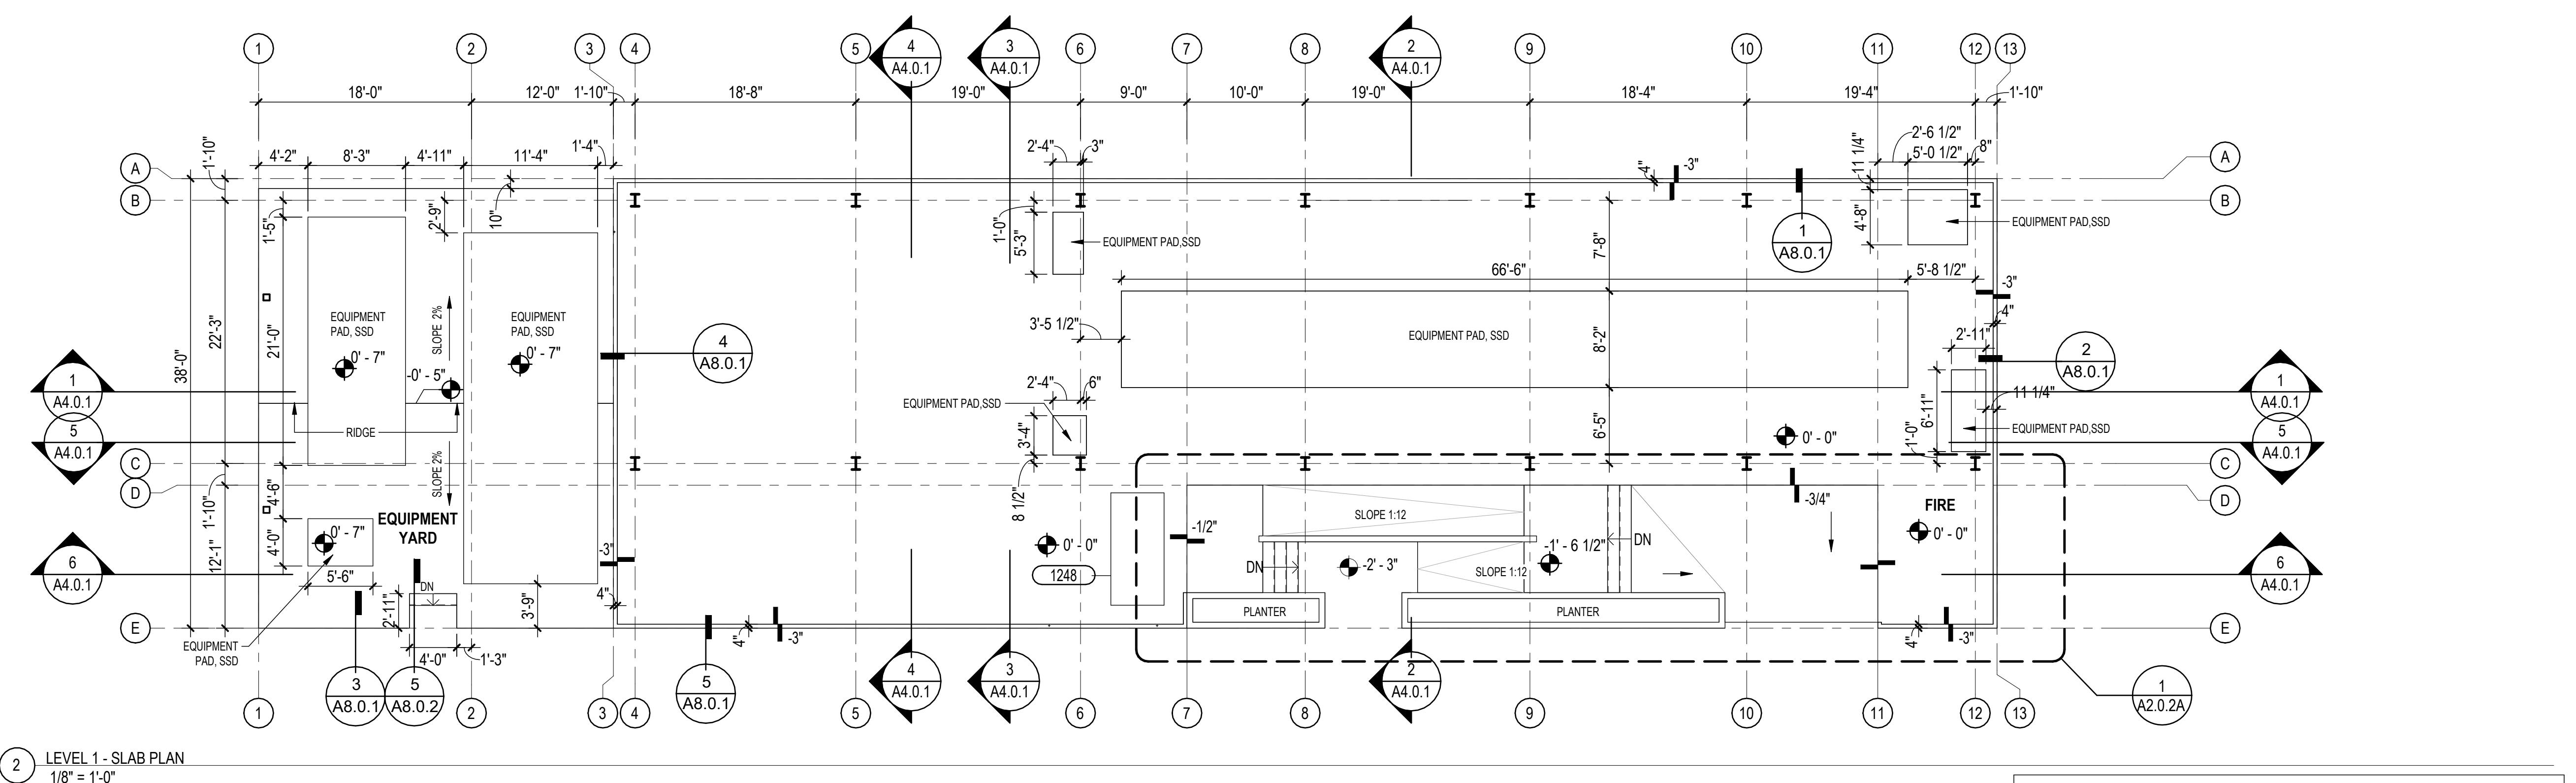
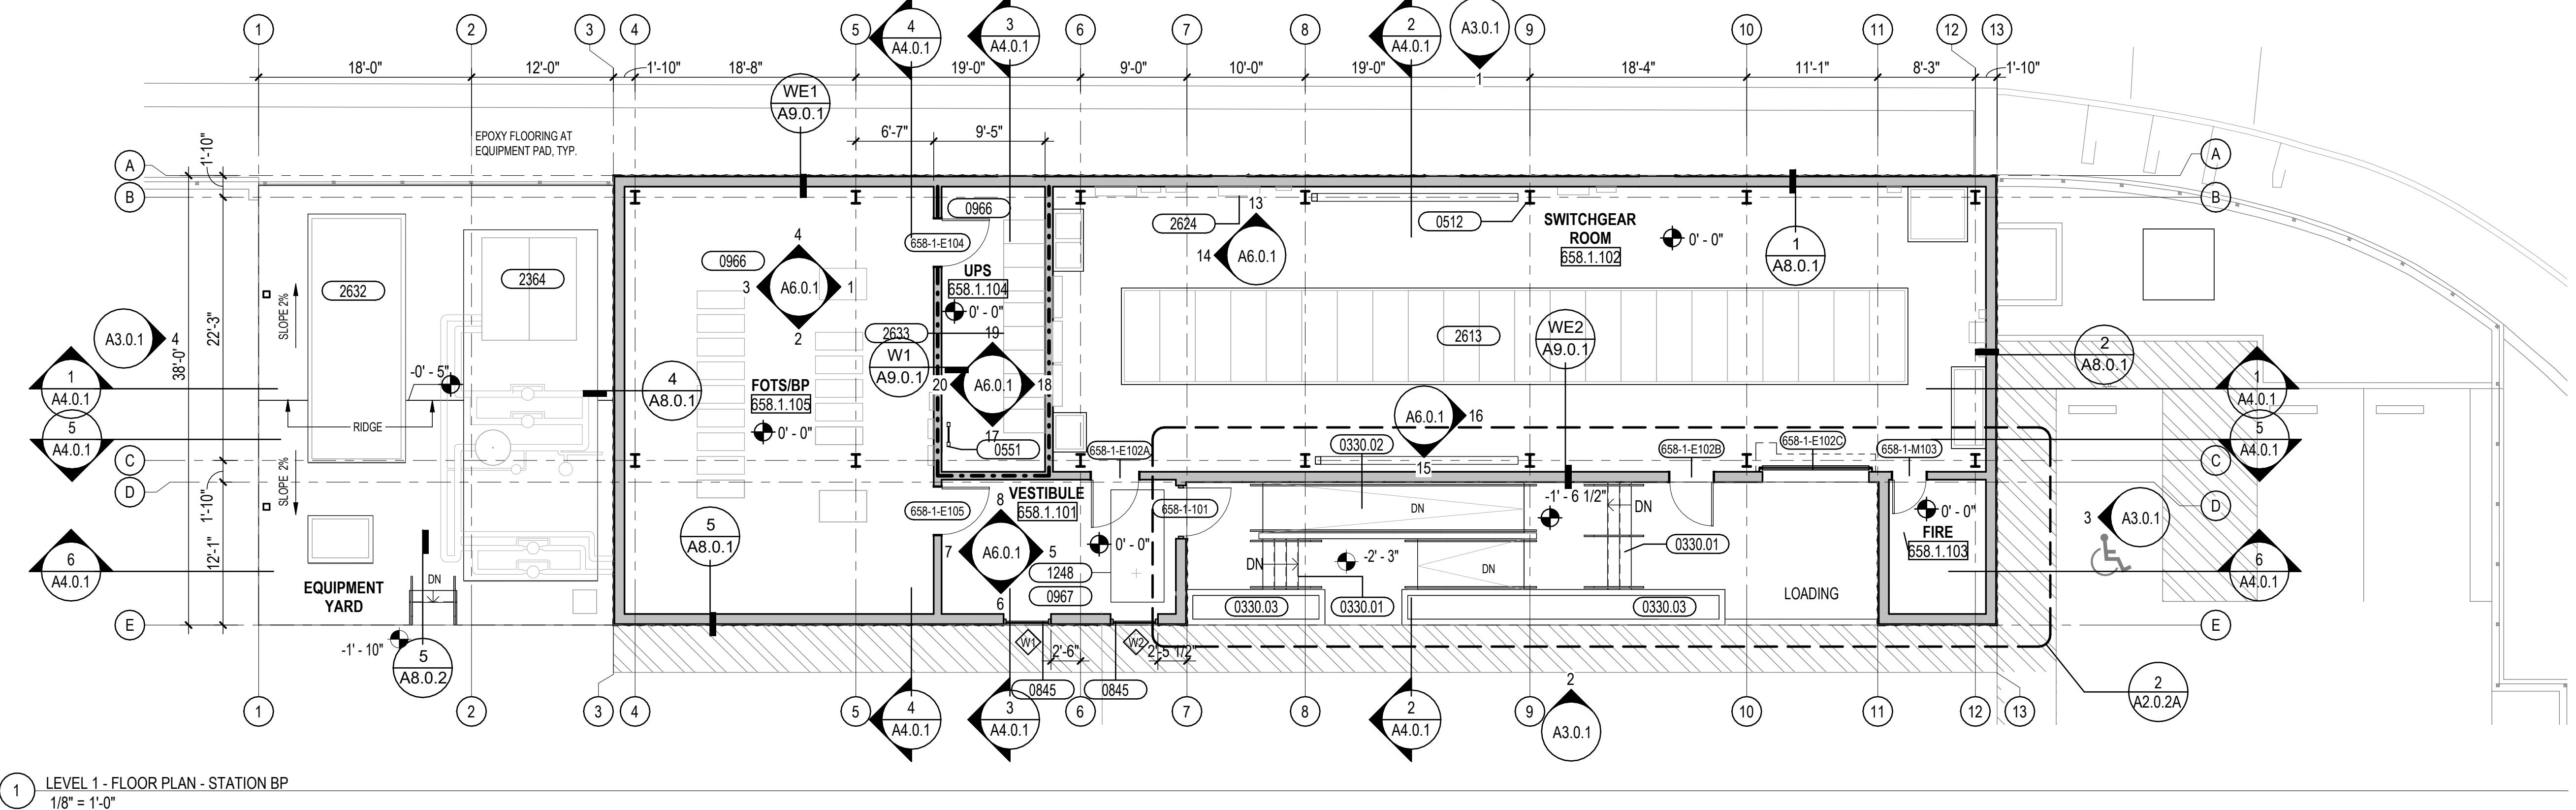
11921.66

LEVEL 1 - FLOOR PLAN, SLAB
- STATION BP

CONTRACT NO. PROJECT TITLE

SEAL CONSULTANT'S LOGO

PTA



BUILDING PLAN GENERAL NOTES

DIMENSION NOTES


1. DIMENSIONS: (U.O.N.)
 - A. TO EDGE OF CONCRETE SLAB
 - B. TO C.L. OF STEEL COLUMN
 - C. TO FACE OF FINISH AT EXTERIOR & INTERIOR WALL
2. GRIDLINES: (U.O.N.)
 - A. AT C.L. OF STEEL COLUMN
 - B. AT FACE OF CONC FOUNDATION WALL
3. LEVELS: FINISH FLOOR ELEVATION (0'-0") = +12.20' ELEVATION, WHICH IS ESTABLISHED BY A REQUIRED MINIMUM 2'-0" ELEVATION ABOVE THE BASE FLOOD ELEVATION OF 10.2' IN ORDER TO COMPLY WITH THE SFO FLOODPLAIN MANAGEMENT ORDINANCE BASED ON A FLOOD 4 CLASSIFICATION.

LEGEND

ROOM INFO	ROOM NAME 101	PARTITION TYPE AM#A.1	TYP. NON-BEARING WALL	ELEVATION VIEW
CALLOUTS TO ENLARGED PLANS	SEE #/ A1.01 SHEET NUMBER DWG NUMBER	EXT. WALL SCHEDULE, SEE A9.00 INT. WALLS, SEE A10.00-A10.0#	1-HR RATED WALL	BUILDING SECTION
GRIDLINES	A CL @ STEEL STRUCTURE, FACE OF CONC @ FOUNDATION WALL	WINDOW SF	INT STOREFRONT SF	SECTION DETAIL
GRIDLINE @ PROPERTY LINE	A	EXT STOREFRONT SF	LOUVER LF	TRUE PROJECT NORTH

KEYNOTE SCHEDULE

NOTE	DESCRIPTION
0330.01	CAST IN PLACE CONCRETE STAIRS AND LANDINGS(S)
0330.02	CAST IN PLACE CONCRETE RAMP
0330.03	CAST IN PLACE CONCRETE PLANTER WITH INTERNAL SCUPPER DRAIN
0512	STRUCTURAL STEEL WITH HIGH-PERFORMANCE COATING- SSD
0551	WALL-MOUNTED STEEL LADDER WITH REQUIRED BLOCKING IN WALL
0845	TRANSLUCENT POLYCARBONATE PANEL, 40MM THICKNESS
0966	EPOXY FLOORING OVER CONCRETE SLAB, ELECTRO-DISCHARGE RESISTANT
0967	EPOXY FLOORING OVER CONCRETE SLAB
1248	RECESSED ENTRY FLOOR MAT, SET FLUSH WITH CONCRETE SLAB
2364	PAD-MOUNTED PACKAGED WATER CHILLERS- SMD
2613	ELECTRICAL SWITCHGEAR- SED
2624	ELEC. SWITCHBOARDS & PANELBOARD, TYP. PROVIDE REQUIRED WALL SUPPORT
2632	PAD-MOUNTED DIESEL GENERATOR- SED
2633	UPS BATTERY EQUIPMENT- SED

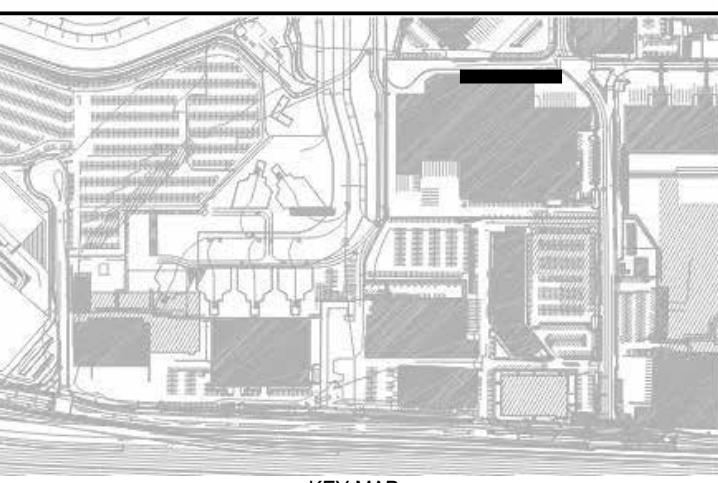

KEY

REVISIONS			
NO	DATE	DESCRIPTION	BY

CONTRACT NO. 11921.66

PROJECT TITLE **WEST FIELD UTILITIES AND PAVING**

SHEET TITLE **ENLARGED PLANS - LOADING DOCK & ENTRY PORCH**

- STATION BP

The image is divided into two main sections by a vertical line. The left section, labeled 'SEAL' at the top, contains a circular seal for Eric S. Robinson. The seal has a double-line border. The outer ring contains the text 'LICENSED ARCHITECT' at the top and 'STATE OF CALIFORNIA' at the bottom, with two small stars on either side of the signature. The inner circle contains the name 'ERIC S. ROBINSON' above a stylized signature. Below the signature are the numbers 'NO. C28139' and 'REN. 12.31.27'. The right section, labeled 'CONSULTANT'S LOGO' at the top, contains a large, bold, gray logo consisting of the letters 'PTA' in a blocky, sans-serif font.

DESIGNED BY: T	CHECKED BY: JT
DRAWN BY: T	DATE: 01/26/2026
SCALE: AS NOTED	SIZE: ARCH-D



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ANCHOR


SHEET NUMBER

A2.0.2A

REVISION

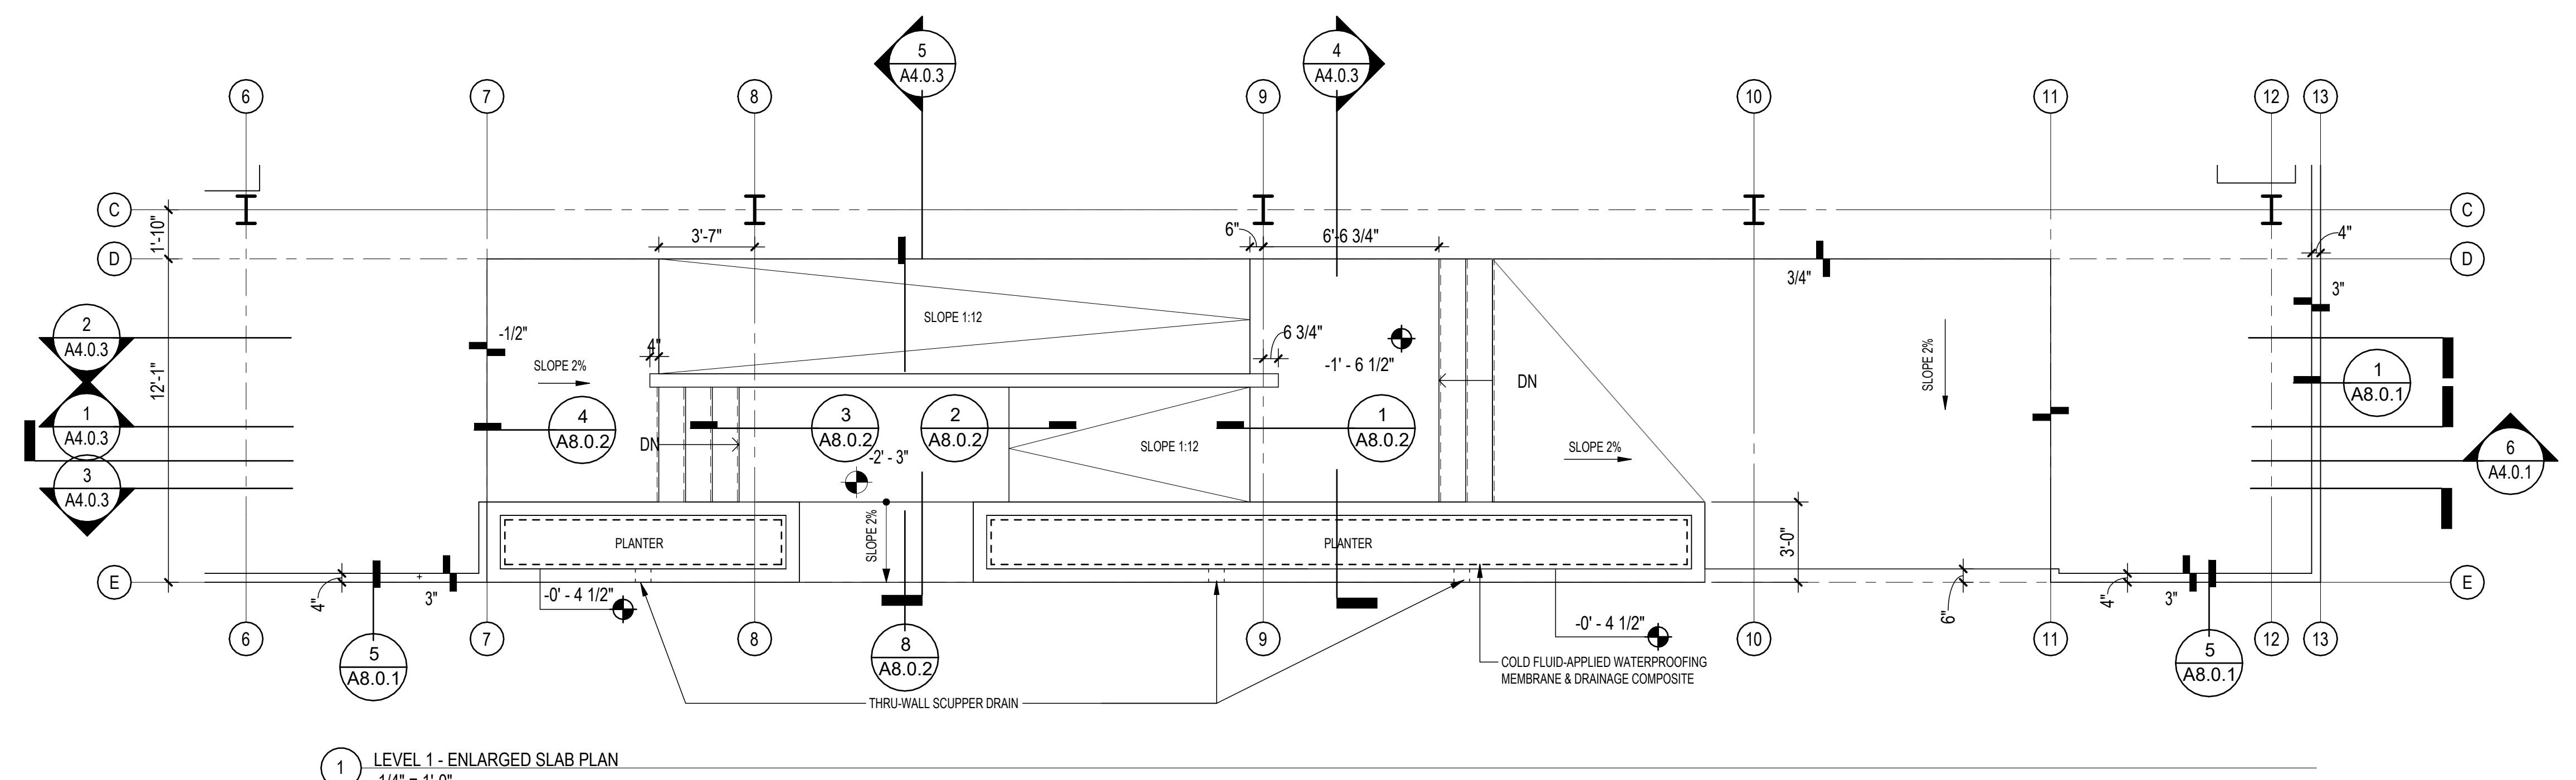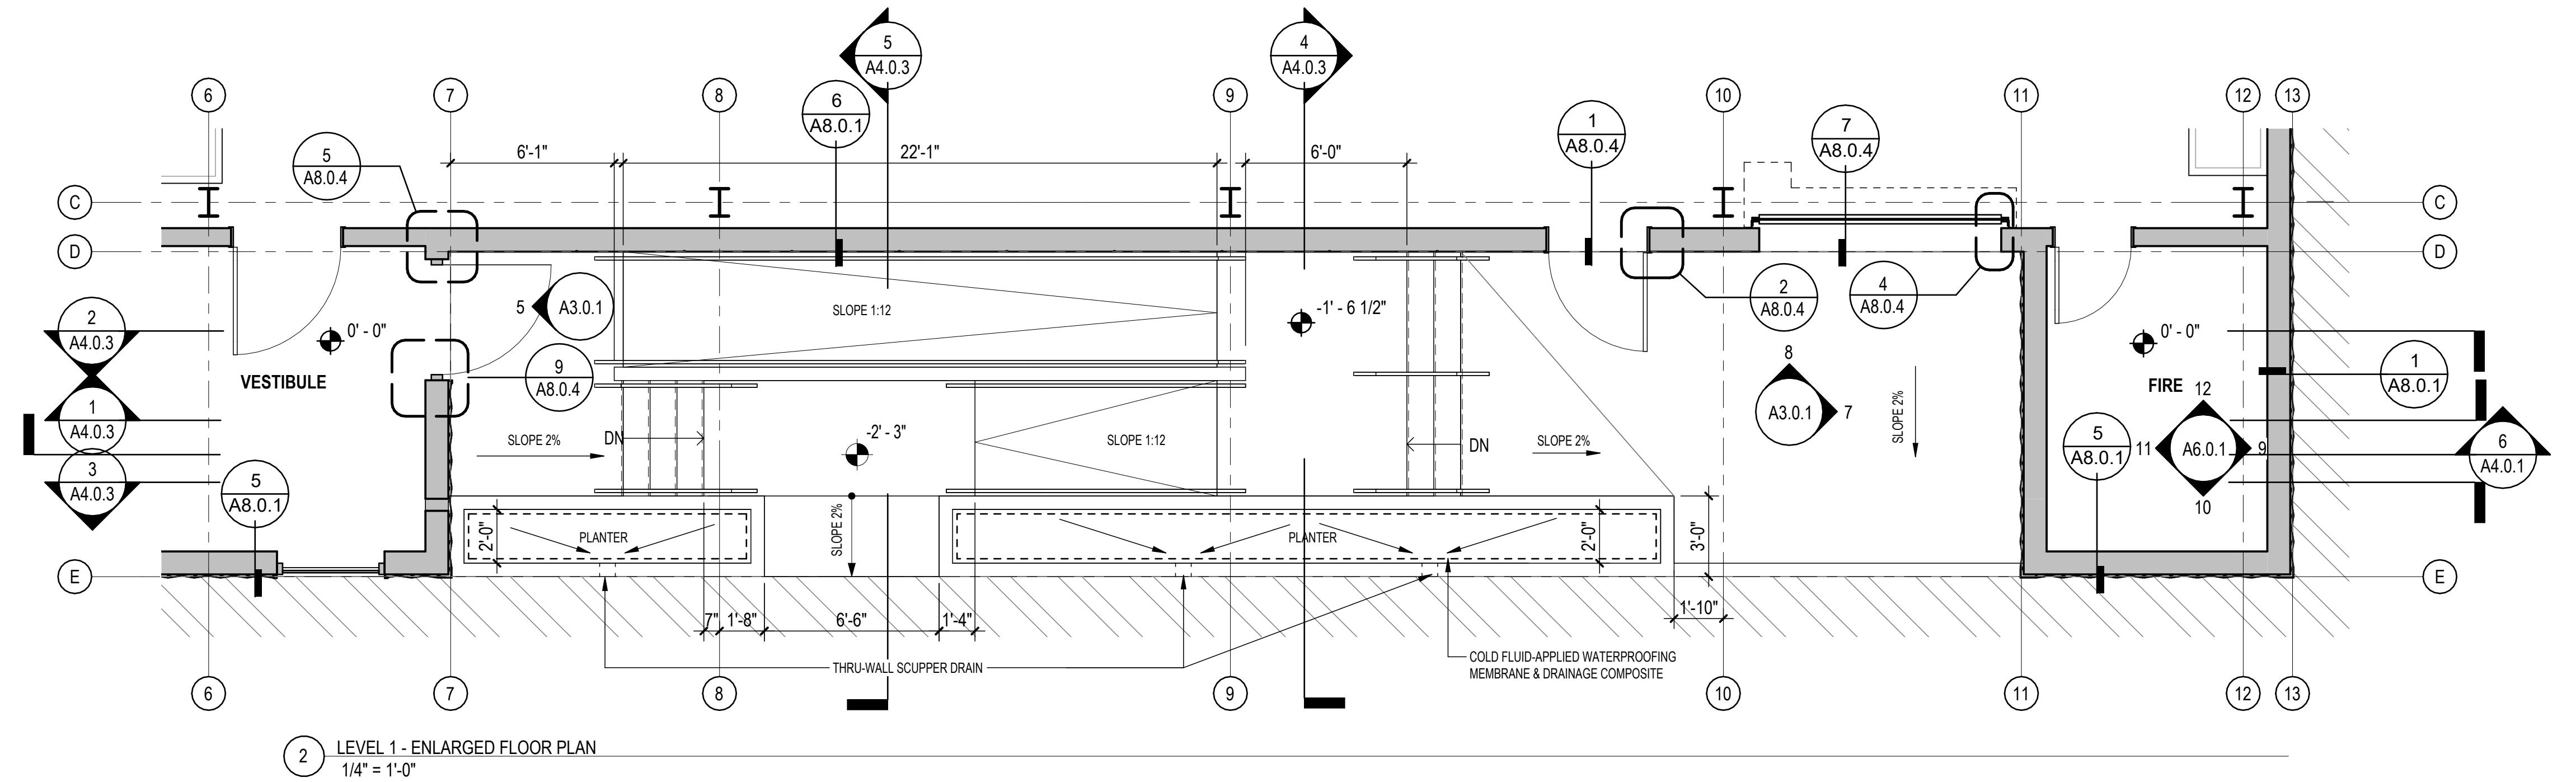

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KEY MAP

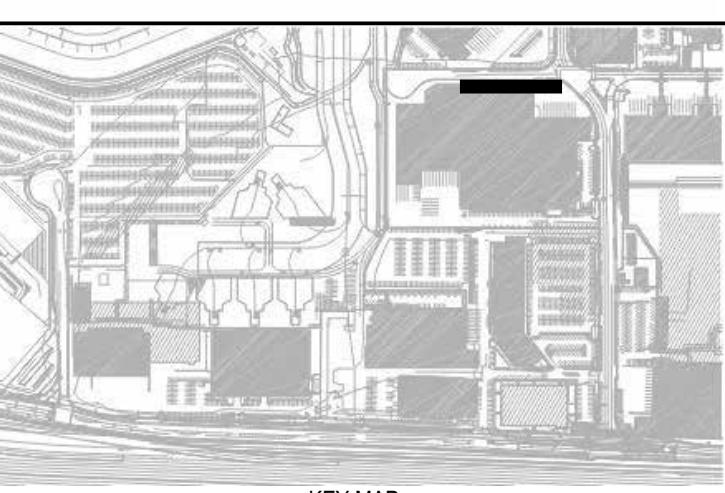

LIGHT FIXTURE SCHEDULE

(A) 4' LINEAR LED SUSPENDED STRIP LIGHT

(B) 4' LINEAR LED RECESSED STRIP LIGHT

(C) RECESSED LED WALL WASH FIXTURE

(D) EXTERIOR WALL-MOUNTED WEDGE FIXTURE

(E) INTERIOR WALL-MOUNTED FIXTURE

(F) EXTERIOR FLOOR-MOUNTED BOLLARD

11921.66

LEVEL 1 - RCP, ROOF PLAN

11921.66

WEST FIELD UTILITIES AND PAVING

11921.66

STATION BP

11921.66

LEVEL 1 - RCP, ROOF PLAN

11921.66

WEST FIELD UTILITIES AND PAVING

11921.66

STATION BP

11921.66

LEVEL 1 - RCP, ROOF PLAN

11921.66

WEST FIELD UTILITIES AND PAVING

11921.66

STATION BP

11921.66

LEVEL 1 - RCP, ROOF PLAN

11921.66

WEST FIELD UTILITIES AND PAVING

11921.66

STATION BP

11921.66

LEVEL 1 - RCP, ROOF PLAN

11921.66

WEST FIELD UTILITIES AND PAVING

11921.66

STATION BP

11921.66

LEVEL 1 - RCP, ROOF PLAN

11921.66

WEST FIELD UTILITIES AND PAVING

11921.66

STATION BP

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LEVEL 1 - RCP, ROOF PLAN

11921.66

WEST FIELD UTILITIES AND PAVING

11921.66

STATION BP

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LEVEL 1 - RCP, ROOF PLAN

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WEST FIELD UTILITIES AND PAVING

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STATION BP

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LEVEL 1 - RCP, ROOF PLAN

11921.66

WEST FIELD UTILITIES AND PAVING

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STATION BP

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LEVEL 1 - RCP, ROOF PLAN

11921.66

WEST FIELD UTILITIES AND PAVING

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LEVEL 1 - RCP, ROOF PLAN

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WEST FIELD UTILITIES AND PAVING

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STATION BP

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LEVEL 1 - RCP, ROOF PLAN

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WEST FIELD UTILITIES AND PAVING

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STATION BP

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LEVEL 1 - RCP, ROOF PLAN

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WEST FIELD UTILITIES AND PAVING

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STATION BP

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LEVEL 1 - RCP, ROOF PLAN

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WEST FIELD UTILITIES AND PAVING

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LEVEL 1 - RCP, ROOF PLAN

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WEST FIELD UTILITIES AND PAVING

11921.66

STATION BP

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LEVEL 1 - RCP, ROOF PLAN

11921.66

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STATION BP

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LEVEL 1 - RCP, ROOF PLAN

11921.66

WEST FIELD UTILITIES AND PAVING

11921.66

STATION BP

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LEVEL 1 - RCP, ROOF PLAN

11921.66

WEST FIELD UTILITIES AND PAVING

11921.66

STATION BP

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LEVEL 1 - RCP, ROOF PLAN

11921.66

WEST FIELD UTILITIES AND PAVING

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STATION BP

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LEVEL 1 - RCP, ROOF PLAN

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WEST FIELD UTILITIES AND PAVING

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STATION BP

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LEVEL 1 - RCP, ROOF PLAN

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WEST FIELD UTILITIES AND PAVING

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STATION BP

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LEVEL 1 - RCP, ROOF PLAN

11921.66

WEST FIELD UTILITIES AND PAVING

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STATION BP

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LEVEL 1 - RCP, ROOF PLAN

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WEST FIELD UTILITIES AND PAVING

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LEVEL 1 - RCP, ROOF PLAN

11921.66

WEST FIELD UTILITIES AND PAVING

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LEVEL 1 - RCP, ROOF PLAN

11921.66

WEST FIELD UTILITIES AND PAVING

11921.66

STATION BP

11921.66

LEVEL 1 - RCP, ROOF PLAN

11921.66

WEST FIELD UTILITIES AND PAVING

11921.66

STATION BP

11921.66

LEVEL 1 - RCP, ROOF PLAN

11921.66

WEST FIELD UTILITIES AND PAVING

11921.66

STATION BP

11921.66

LEVEL 1 - RCP, ROOF PLAN

11921.66

WEST FIELD UTILITIES AND PAVING


11921.66

STATION BP


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LEVEL 1 - RCP, ROOF PLAN


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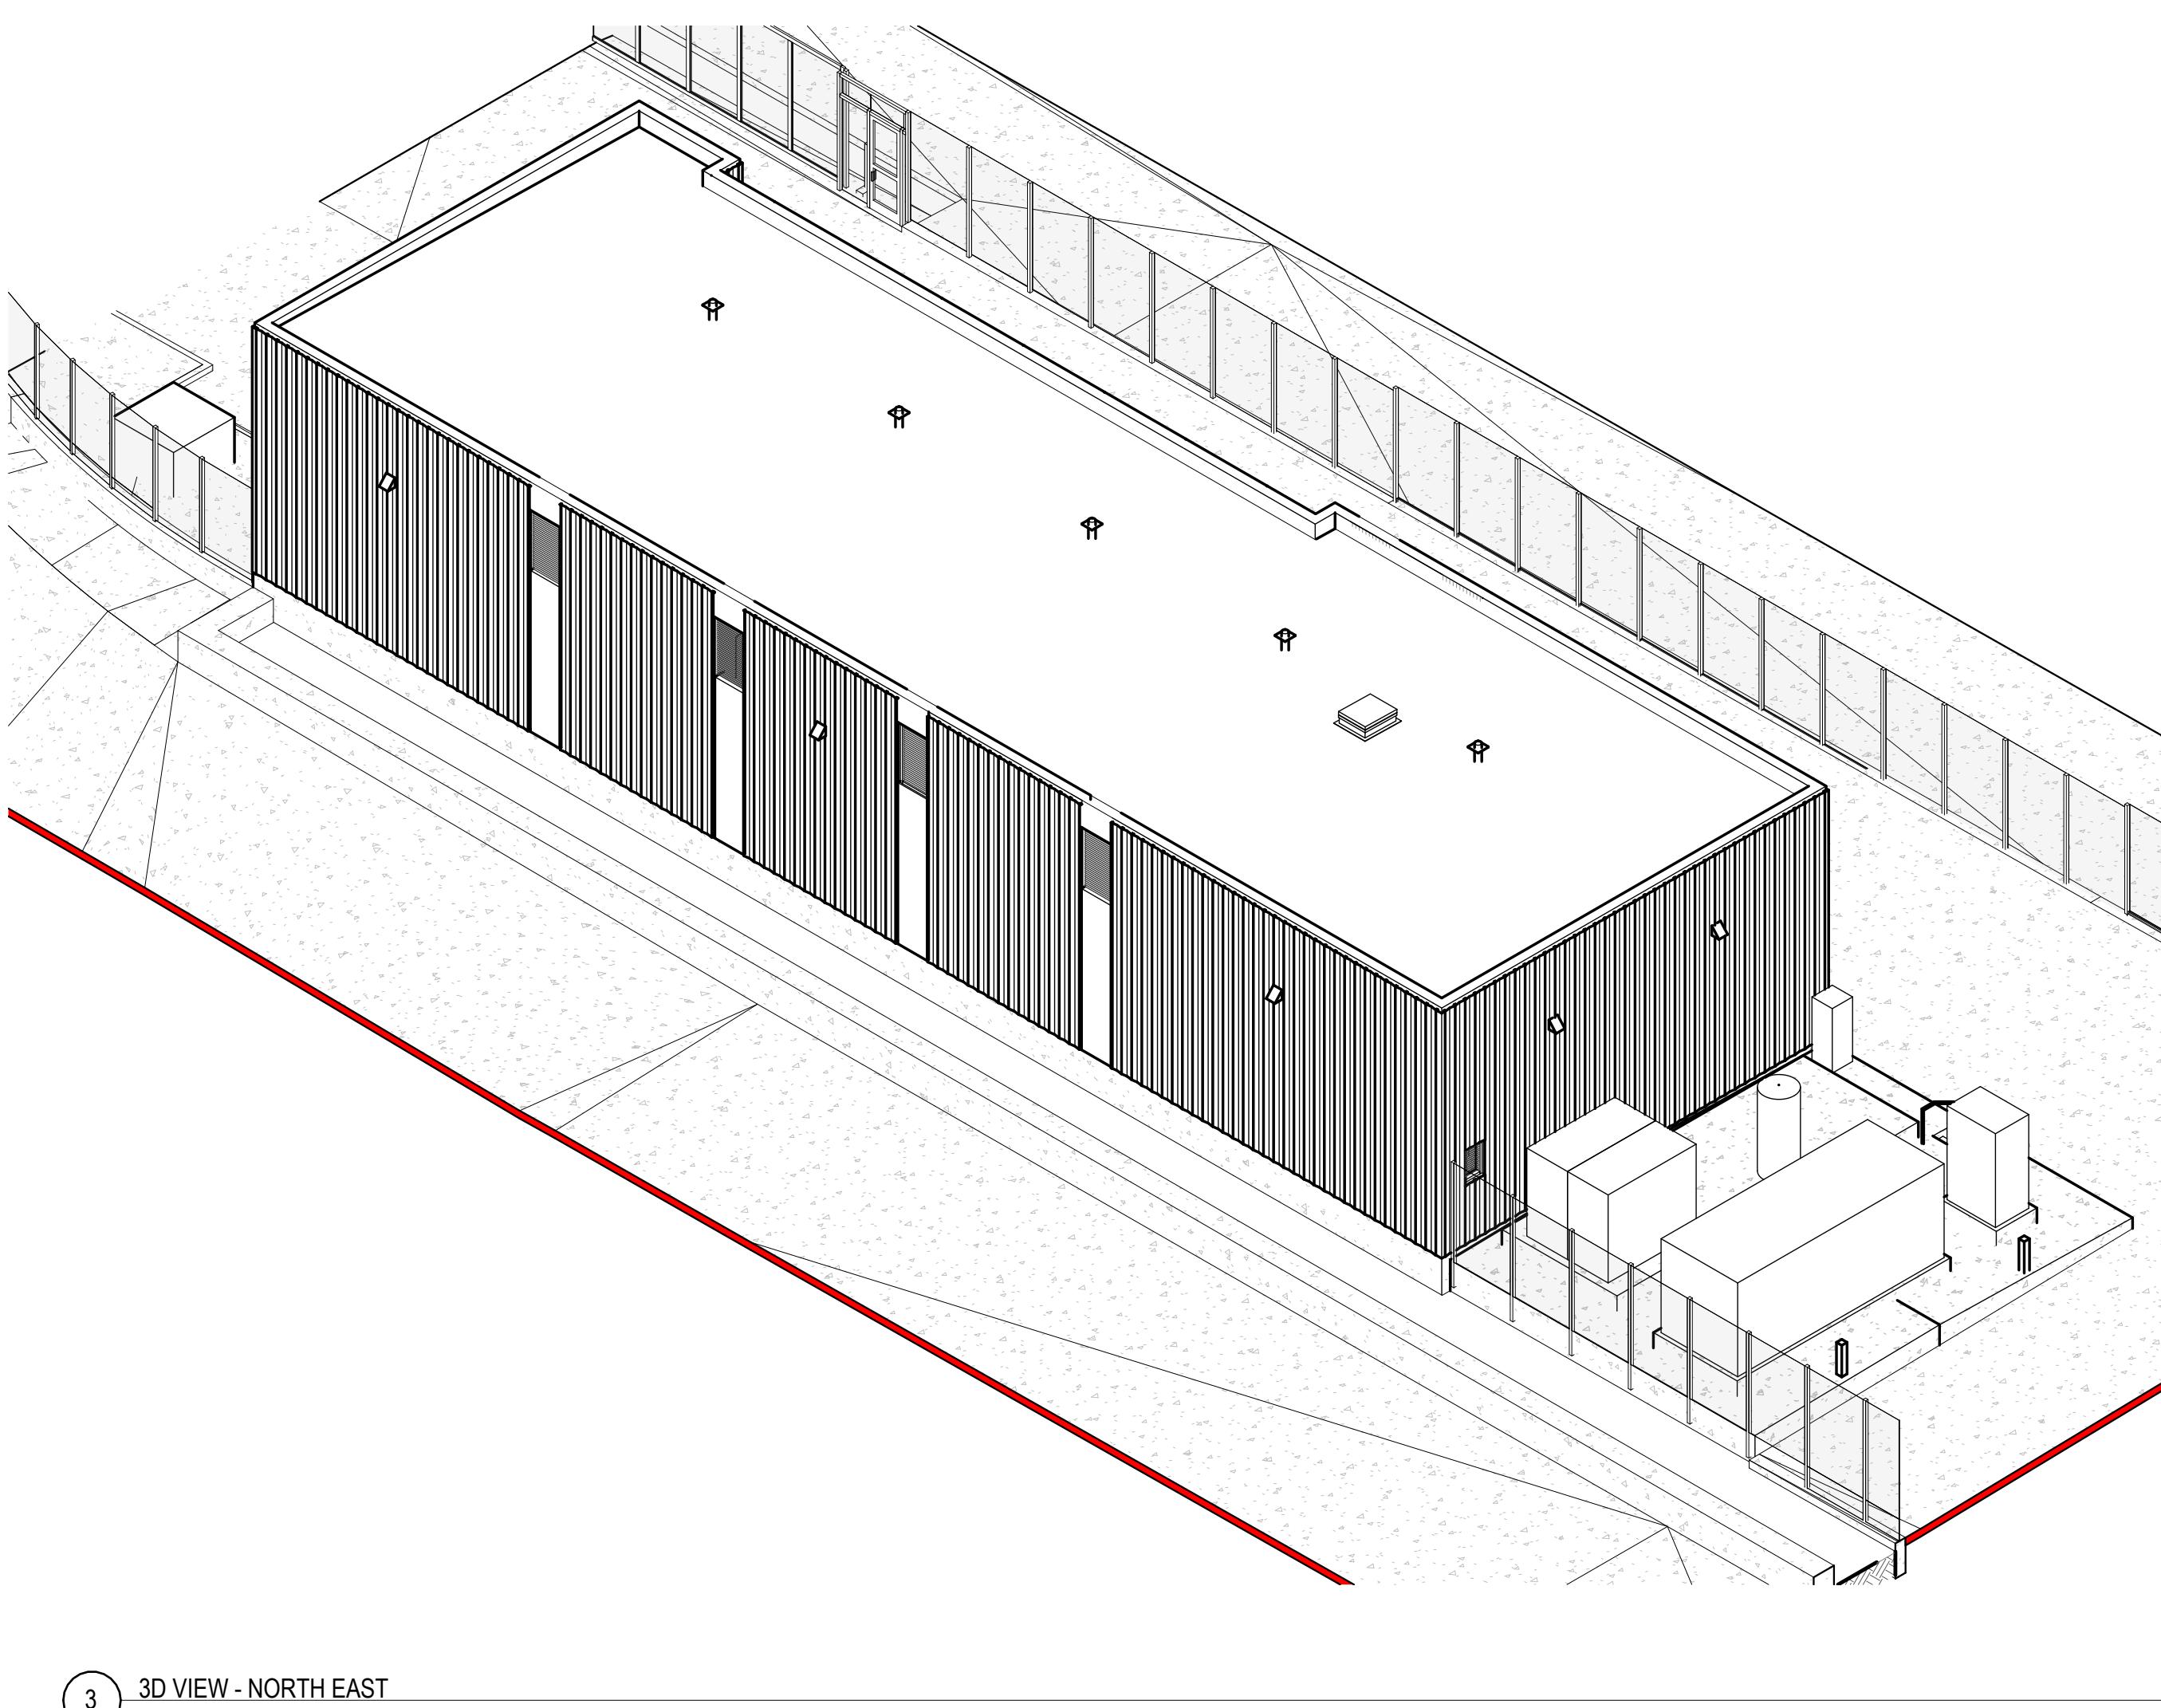
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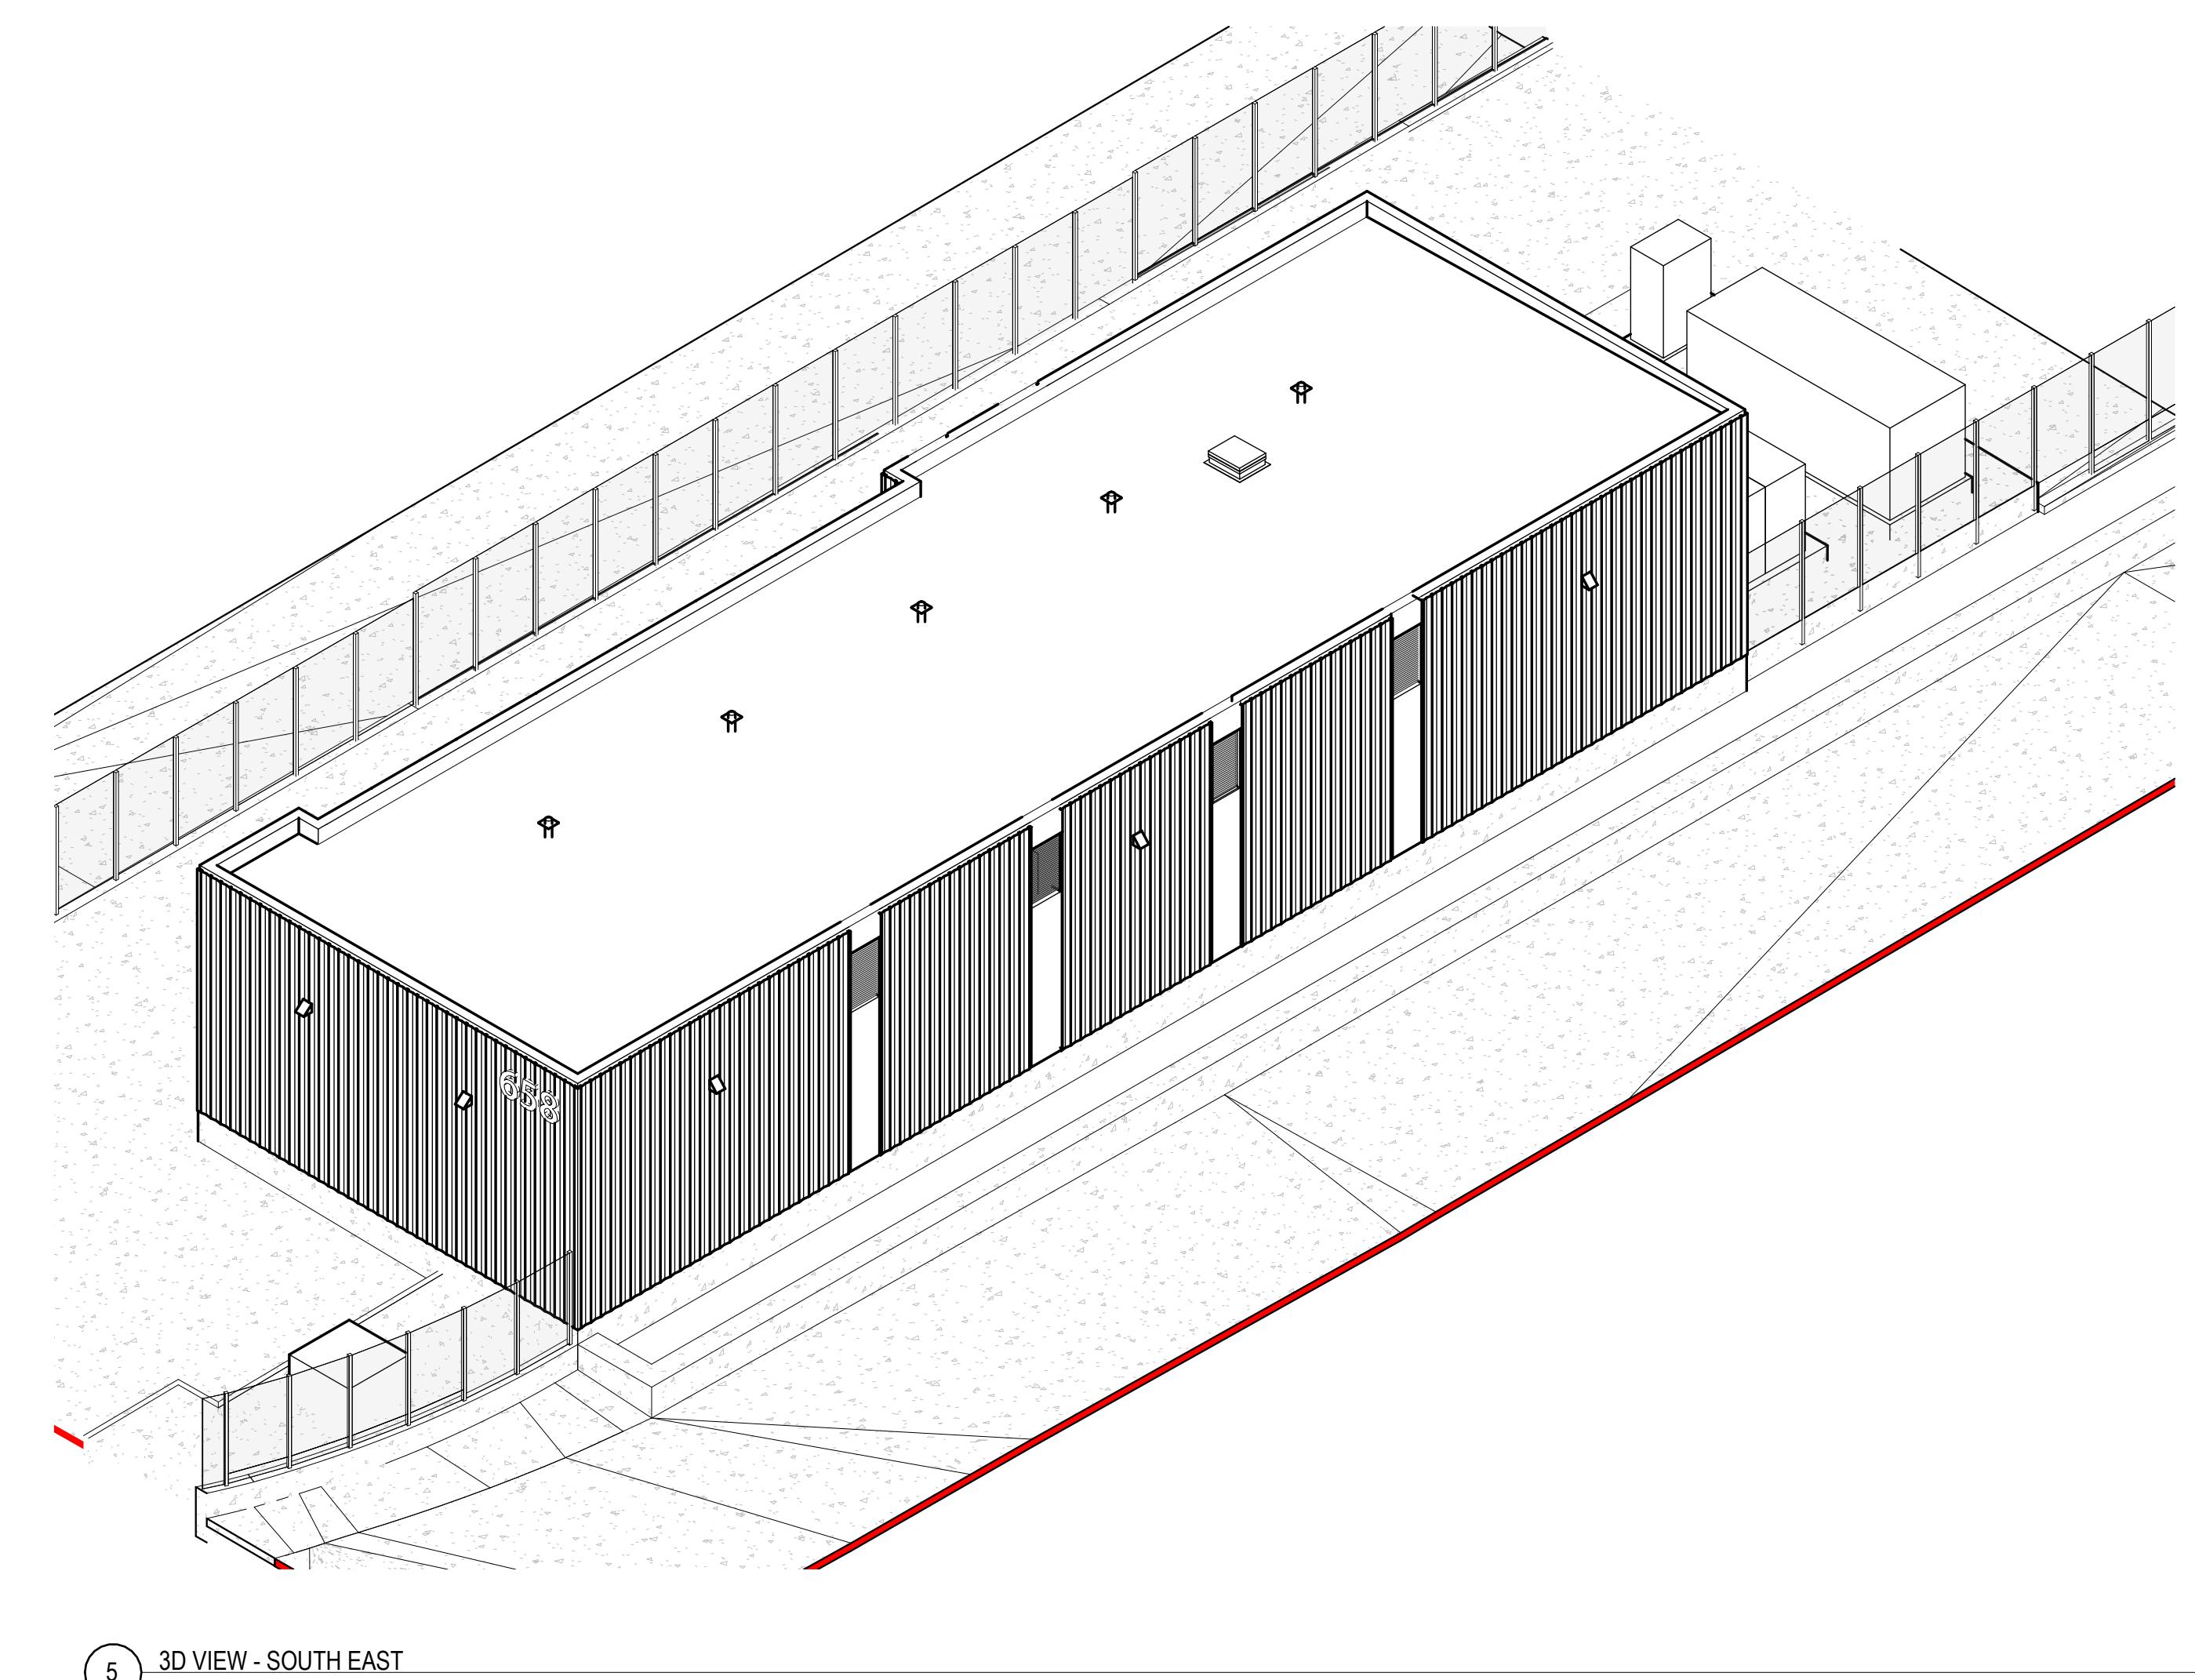
4 3D VIEW - NORTH WEST

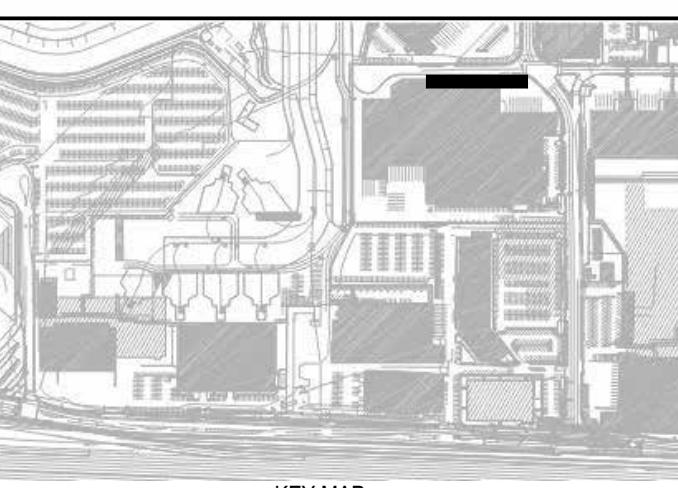

1 3D VIEW - SOUTH WEST

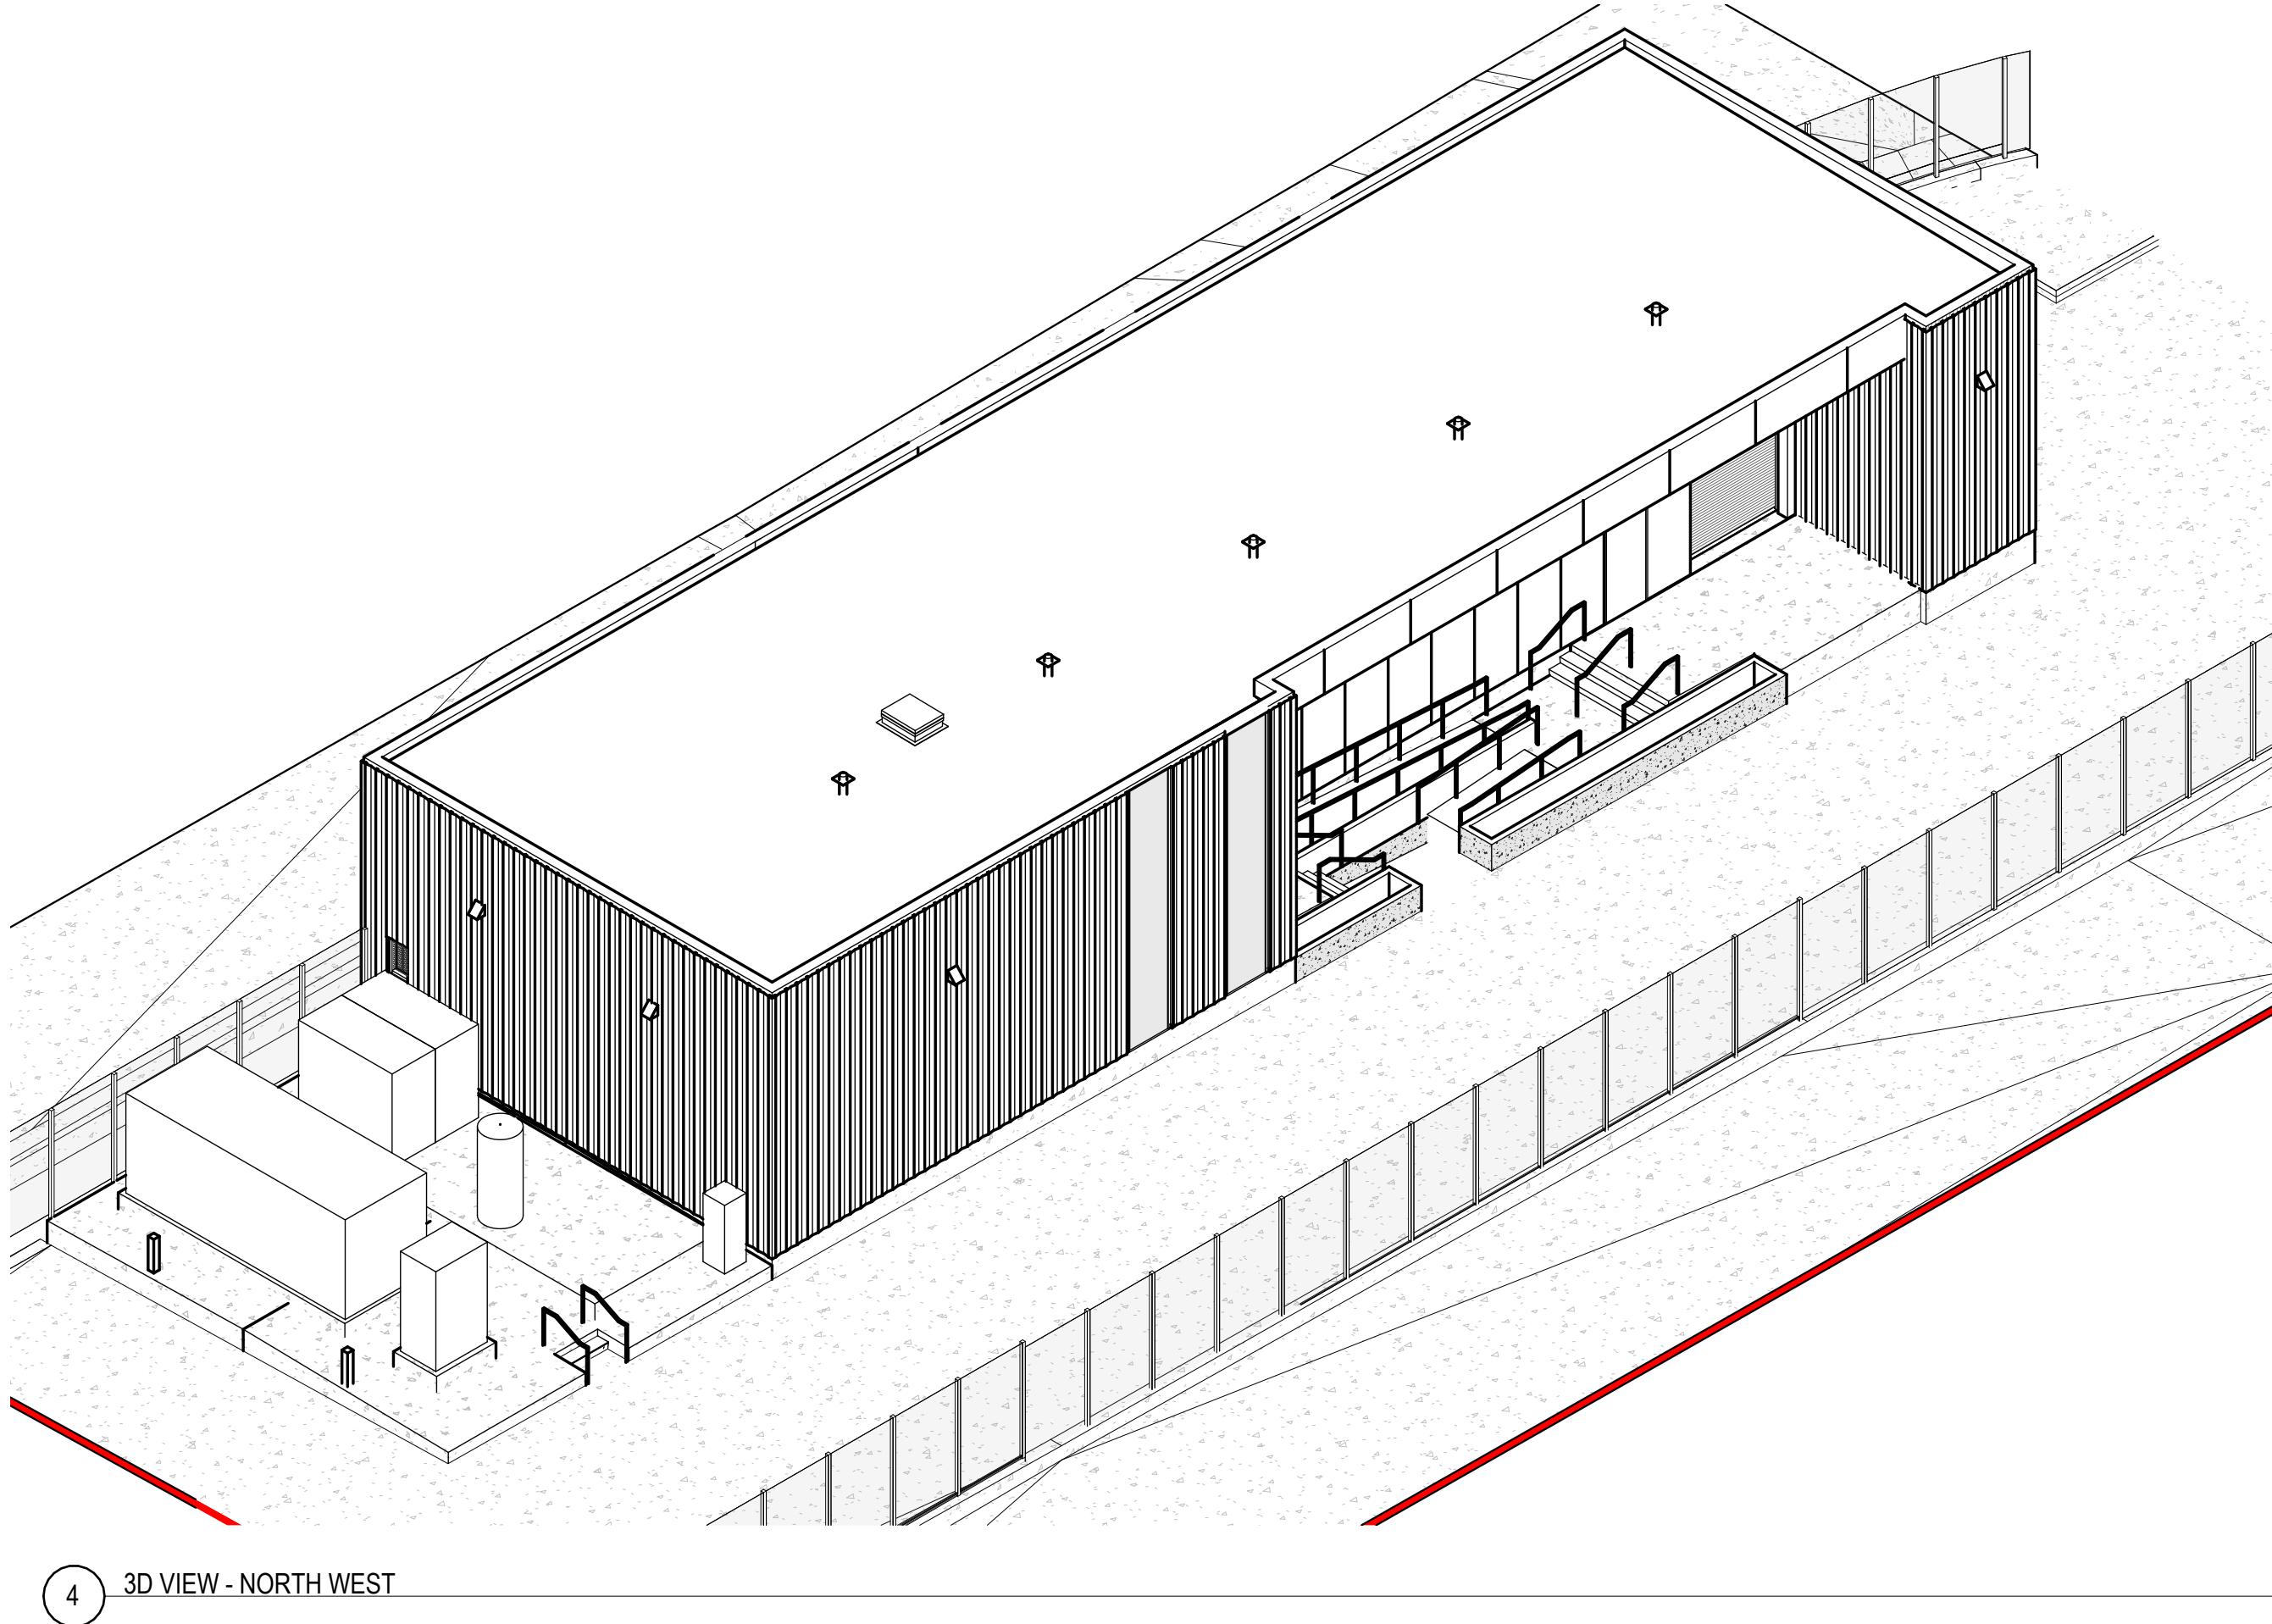

3 3D VIEW - NORTH EAST

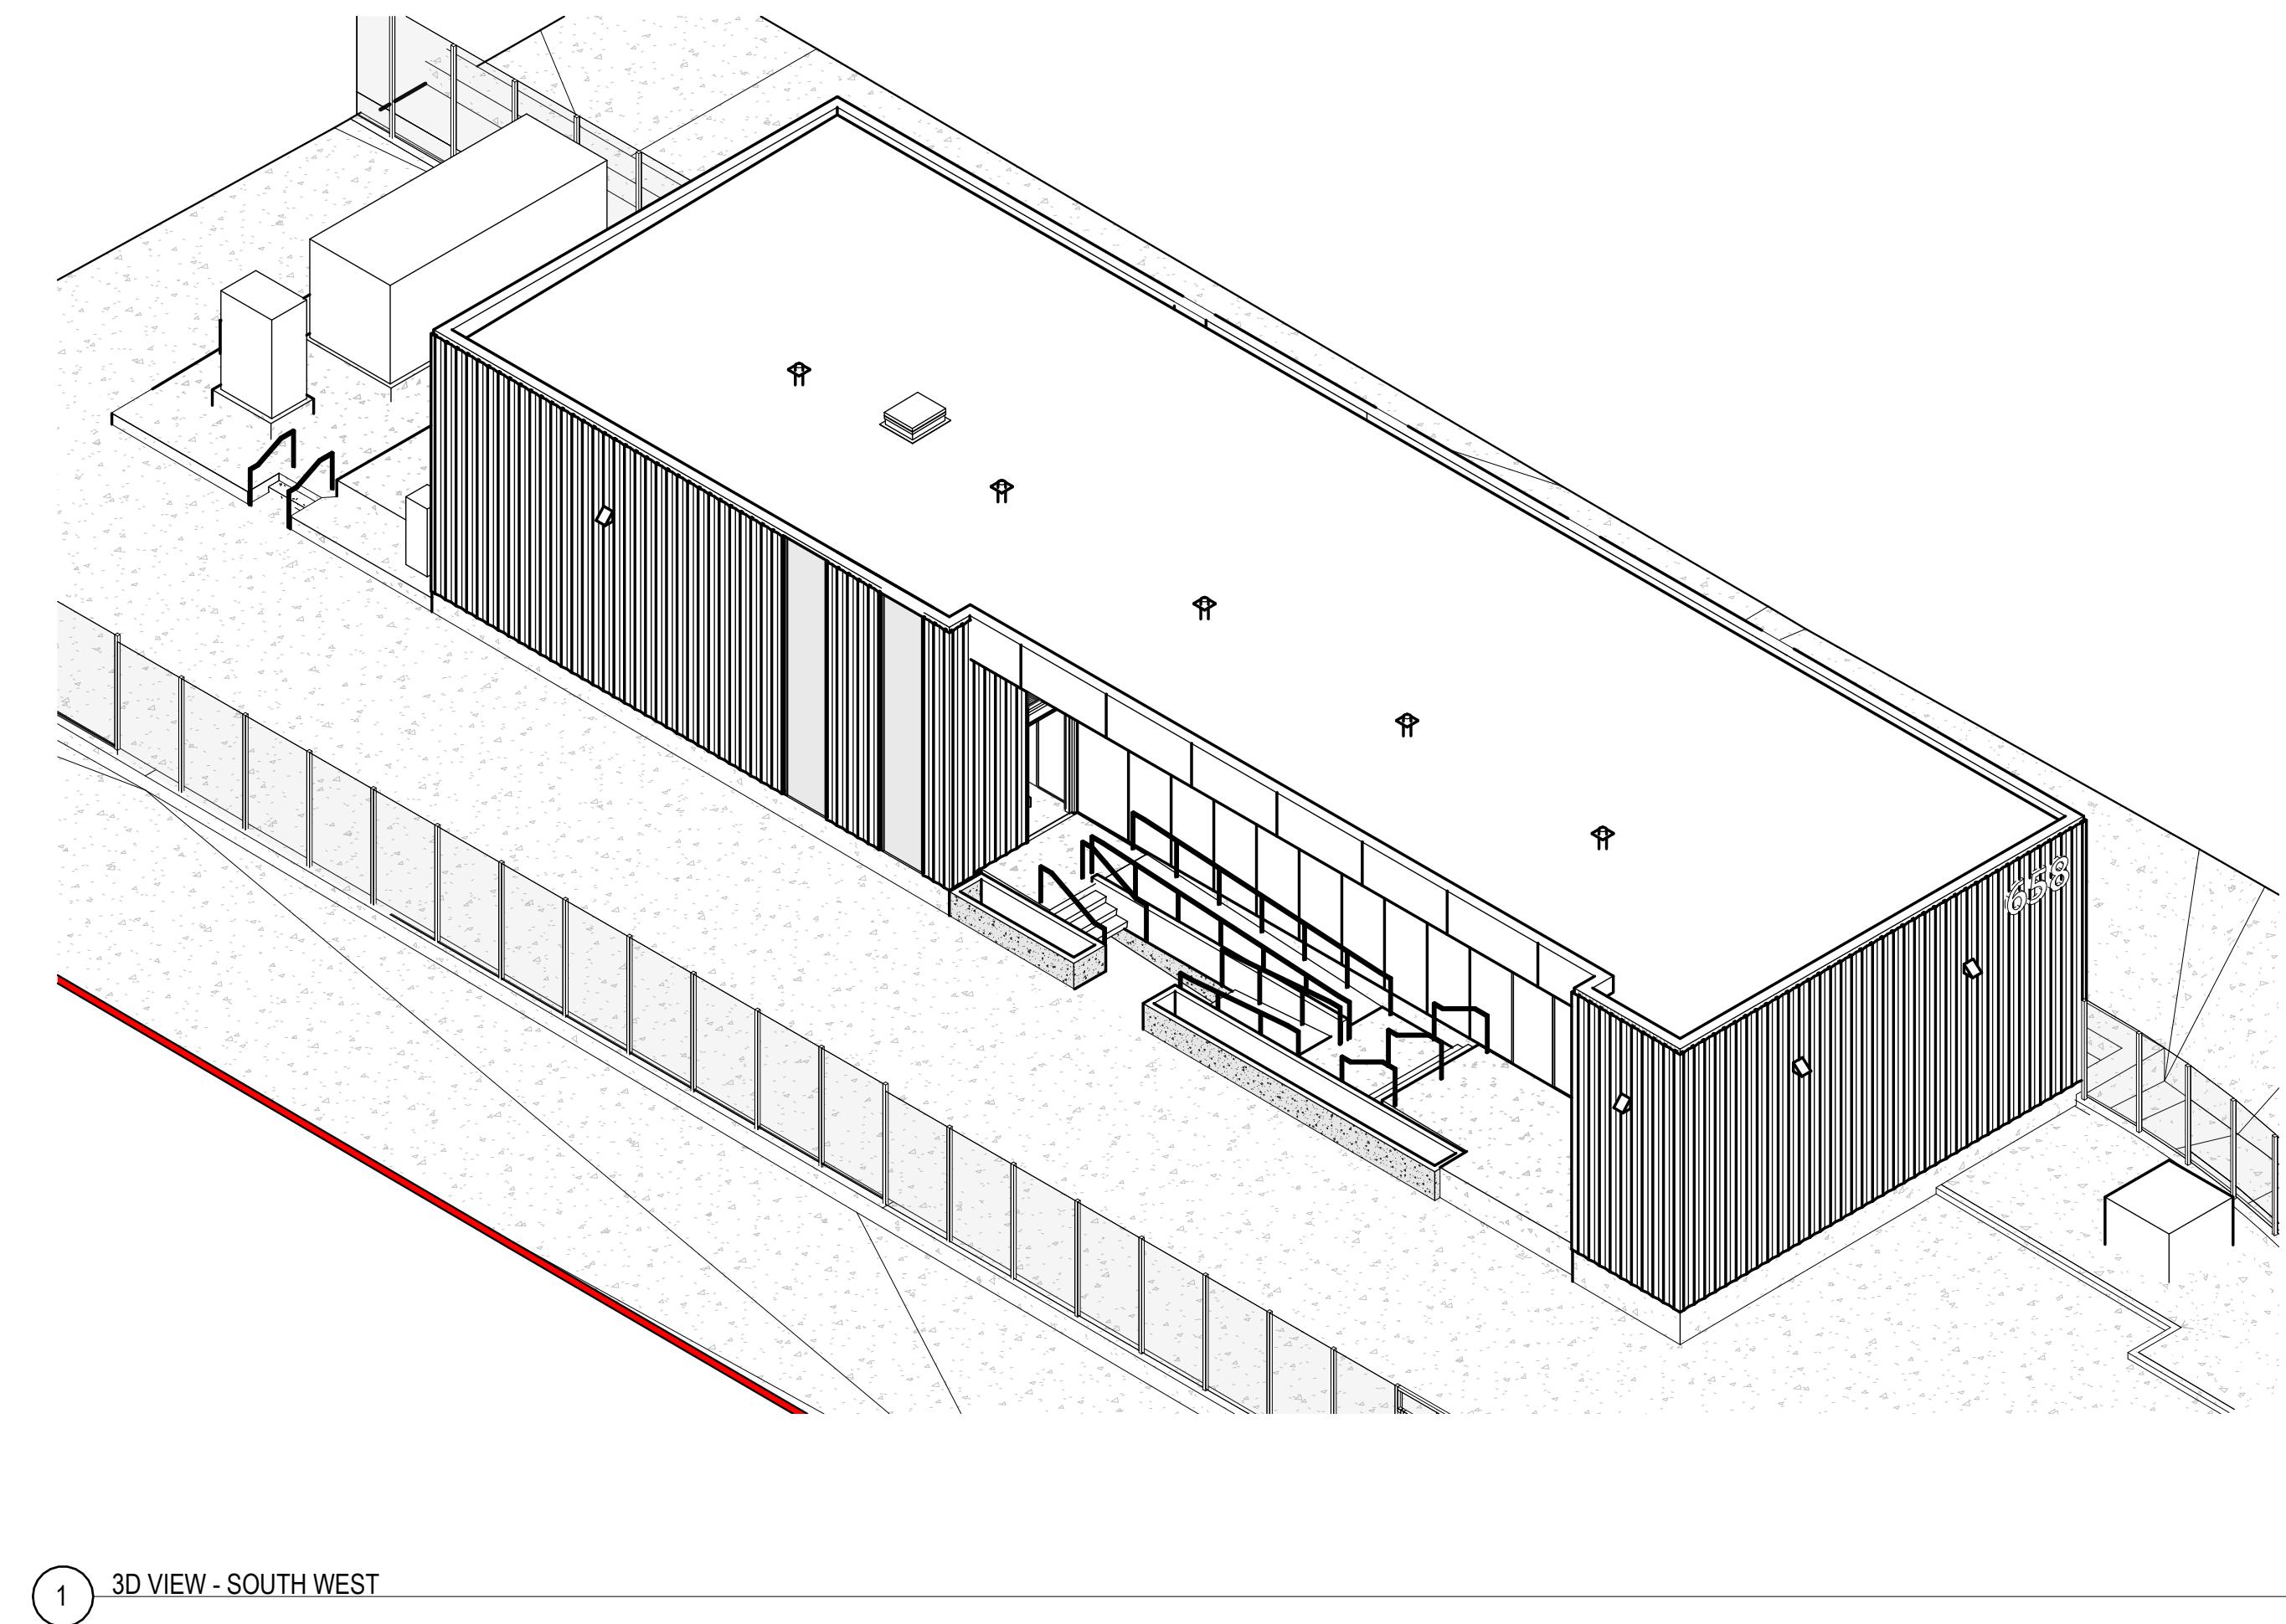

5 3D VIEW - SOUTH EAST

REVISIONS	
NO	DATE
DESCRIPTION	
BY	
PROJECT TITLE	
CONTRACT NO.	
SHEET TITLE	
CONSULTANT'S LOGO	
PTA	
A3.0.0	
REVISION	
OF	

11921.66

WEST FIELD UTILITIES AND PAVING - STATION BP

3D VIEWS

DESIGNED BY: **JT** CHECKED BY: **JT**
DRAWN BY: **JT** DATE: **01/26/2026**
SCALE: **AS NOTED** SIZE: **ARCH-D**
SHEET NUMBER: **11921.66**

NOTE: If this drawing is not on 24" x 36", it has been revised from its original size. Scales as noted on drawings / details are no longer applicable.


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Autodesk AutoCAD 2026

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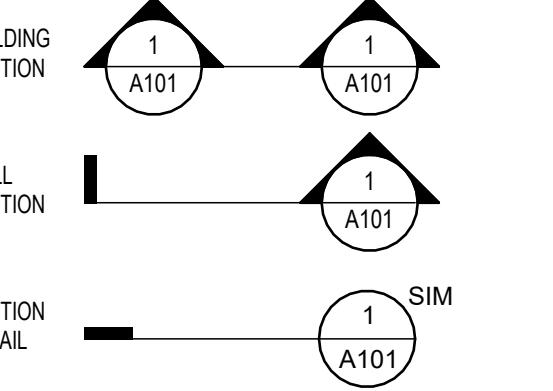
SFO

SAN FRANCISCO
INTERNATIONAL AIRPORT

EXTERIOR ELEVATION GENERAL NOTES

KEYNOTE 1.01 DWG NUMBER
DETAIL 1 SIM REFERENCE LABEL
A101 SHEET NUMBER

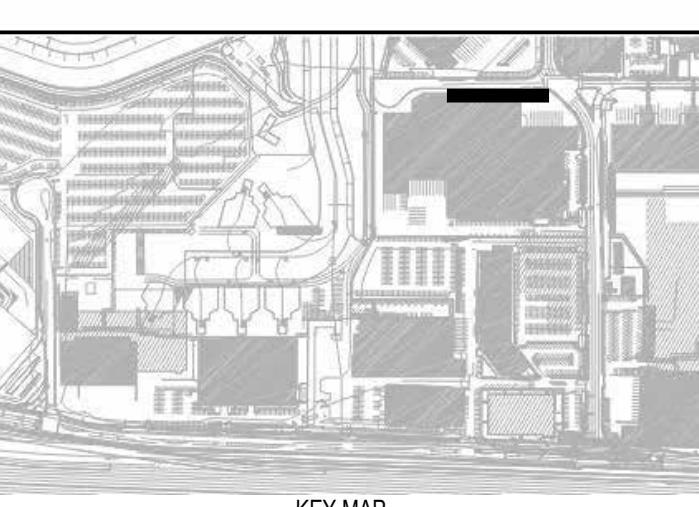FOR TYP. WINDOW SILL HEIGHTS, SILL HEIGHTS NOTED ON EXTERIOR ELEVATIONS ARE EXCEPTIONS.



1. ARCHITECTURAL +0-0" IS +82.00", S.C.D.
2. FLOOR ELEVATIONS MEASURED TO T.O. CONC. @ CONC. SLAB FLOORS
3. ROOF ELEVATIONS MEASURED TO T.O. ROOF SHEATHING
4. ANTI-GRAFFITI FILM ON GLAZING AND GRAFFITI-RESISTANT COATING ON ALL OTHER EXTERIOR SURFACES UP TO +10-0".

EXTERIOR ELEVATION MATERIALS LEGEND

- [1] V-PROFILE ALUMINUM WALL PANEL- POWDERCOAT FINISH
- [2] POLYCARBONATE PANEL (TRANSLUCENT)
- [3] CAST-IN-PLACE CONCRETE- CLEAR SEALER
- [4] ALUMINUM COPING- POWDERCOAT FINISH
- [5] FLAT ALUMINUM COMPOSITE METAL (ACM) PANEL - POWDERCOAT FINISH
- [6] HIGH PRESSURE LAMINATE PANEL (COLOR 1)
- [7] ALUMINUM LOUVER- POWDERCOAT FINISH

KEYNOTE SCHEDULE	
NOTE	DESCRIPTION
1014	WALL-MOUNTED BUILDING SIGNAGE NUMBER, INTERNALLY-ILLUMINATED
2656	EXTERIOR LIGHTING, WALL-MOUNTED WEDGE-TYPE DOWNLIGHT- SED

REVISIONS	DESCRIPTION
NO DATE	


11921.66	WEST FIELD UTILITIES AND PAVING - STATION BP
CONTRACT NO.	PROJECT TITLE

EXTERIOR ELEVATIONS - ENLARGED	
SEAL	CONSULTANT'S LOGO
	PTA
CONTRACT NO.	PROJECT TITLE
11921.66	WEST FIELD UTILITIES AND PAVING - STATION BP
SHEET TITLE	
DESIGNED BY: JT	CHECKED BY: JT
DRAWN BY: XX	DATE: 01/26/2026
SCALE: AS NOTED	SIZE: ARCH-D
SHEET NUMBER	

A3.0.2


REVISION

OF

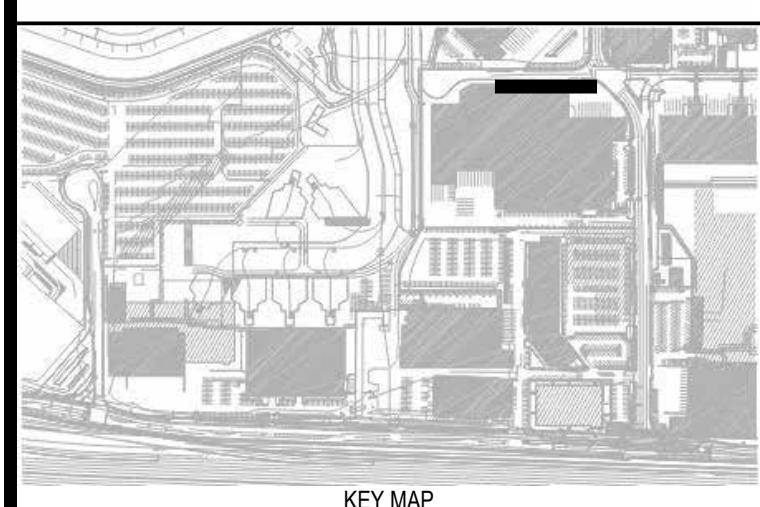

EXTERIOR ELEVATION GENERAL NOTES

KEYNOTE
DETAIL
FOR TYP. WINDOW SILL HEIGHTS, SILL HEIGHTS NOTED ON EXTERIOR ELEVATIONS ARE EXCEPTIONS.

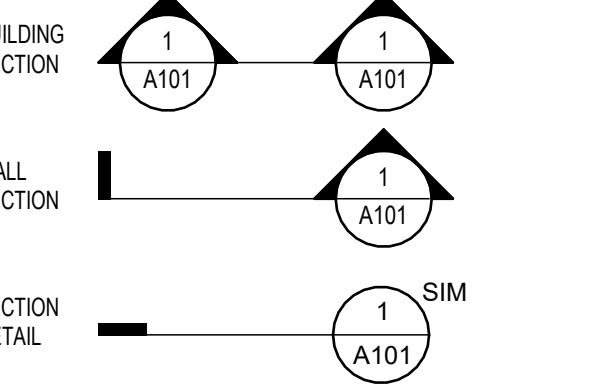

1. ARCHITECTURAL +0'-0" IS +82.00', S.C.D.
2. FLOOR ELEVATIONS MEASURED TO T.O. CONC. @ CONC. SLAB FLOORS
3. ROOF ELEVATIONS MEASURED TO T.O. ROOF SHEATHING
4. ANTI-GRAFFITI FILM ON GLAZING AND GRAFFITI-RESISTANT COATING ON ALL OTHER EXTERIOR SURFACES UP TO +10'-0".

EXTERIOR ELEVATION MATERIALS LEGEND

- 1 V-PROFILE ALUMINUM WALL PANEL- POWDERCOAT FINISH
- 2 POLYCARBONATE PANEL (TRANSLUCENT)
- 3 CAST-IN-PLACE CONCRETE- CLEAR SEALER
- 4 ALUMINUM COPING- POWDERCOAT FINISH
- 5 FLAT ALUMINUM COMPOSITE METAL (ACM) PANEL- POWDERCOAT FINISH
- 6 HIGH PRESSURE LAMINATE PANEL (COLOR 1)
- 7 ALUMINUM LOUVER- POWDERCOAT FINISH

KEYNOTE SCHEDULE	
NOTE	DESCRIPTION
2214.01	COMBINATION ROOF DRAIN & OVERFLOW, DRAINED TO EXTERIOR OUTLETS
2656	EXTERIOR LIGHTING, WALL-MOUNTED WEDGE-TYPE DOWNLIGHT- SED

REVISIONS	DESCRIPTION
NO DATE	


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SEAL	CONSULTANT'S LOGO

11921.66


WEST FIELD UTILITIES AND PAVING - STATION BP

EXTERIOR ELEVATIONS - ENLARGED


DESIGNED BY: JT	CHECKED BY: JT
DRAWN BY: JT	DATE: 01/26/2026
SCALE: AS NOTED	SIZE: ARCH-D
SHEET NUMBER	
REVISION	
A3.0.3	

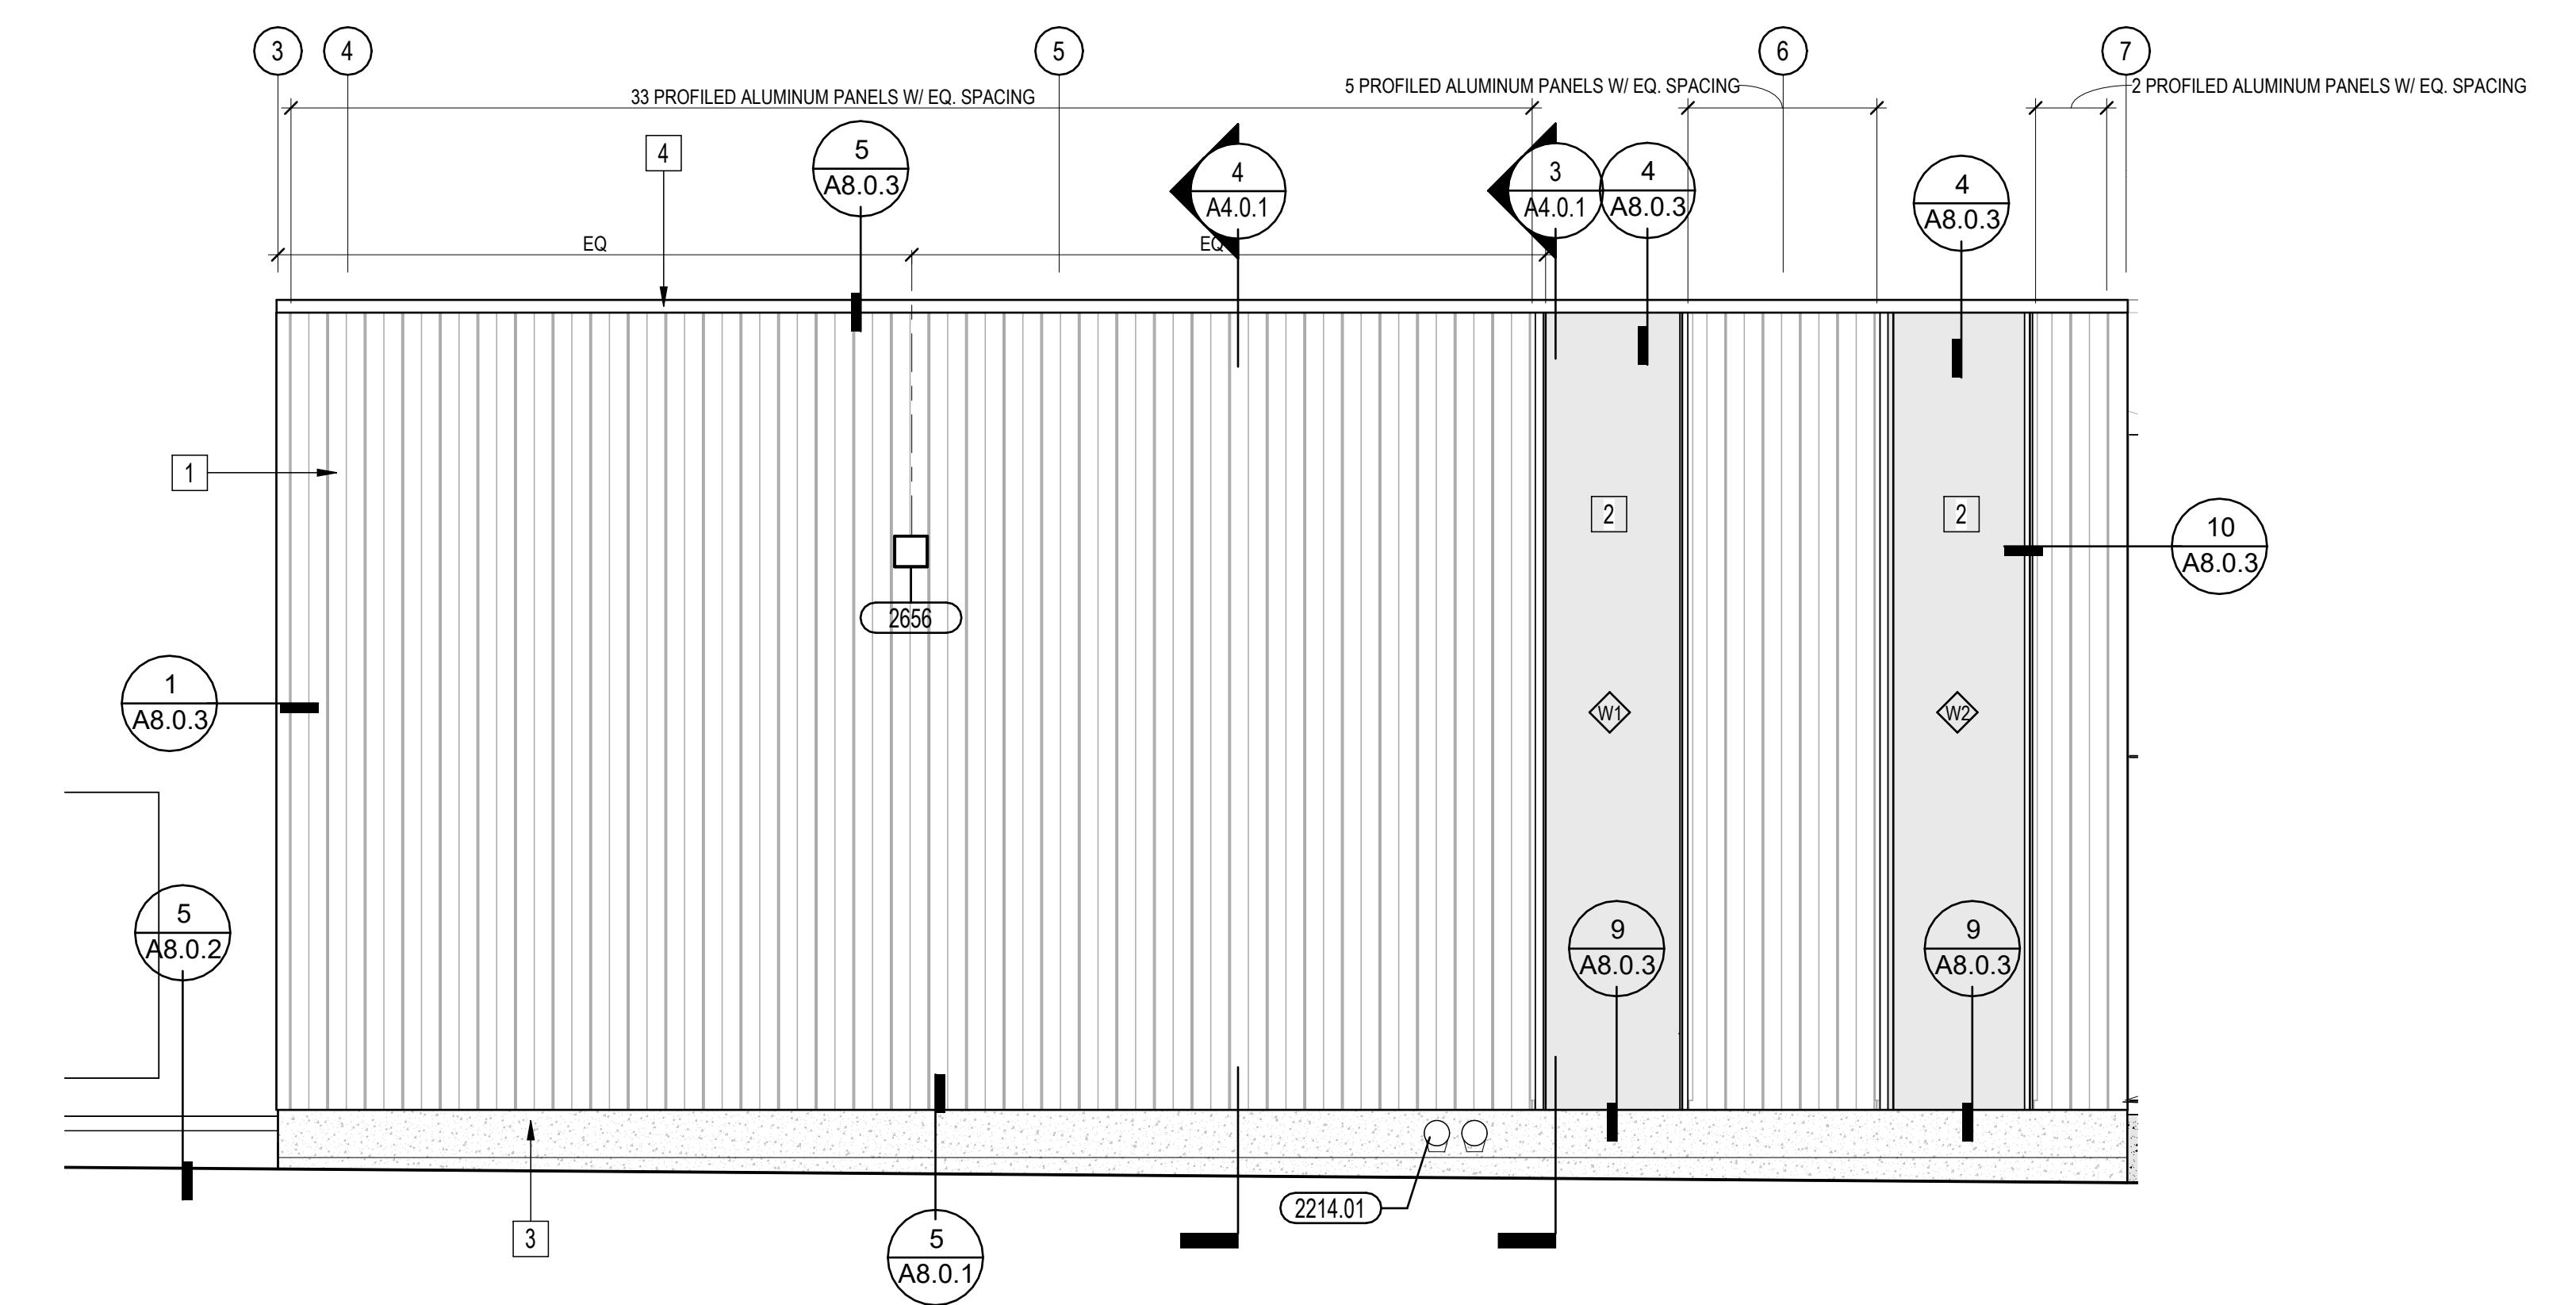

5 ENLARGED ELEVATION - DRIVE AISLE (WEST) - A
1/4" = 1'-0"

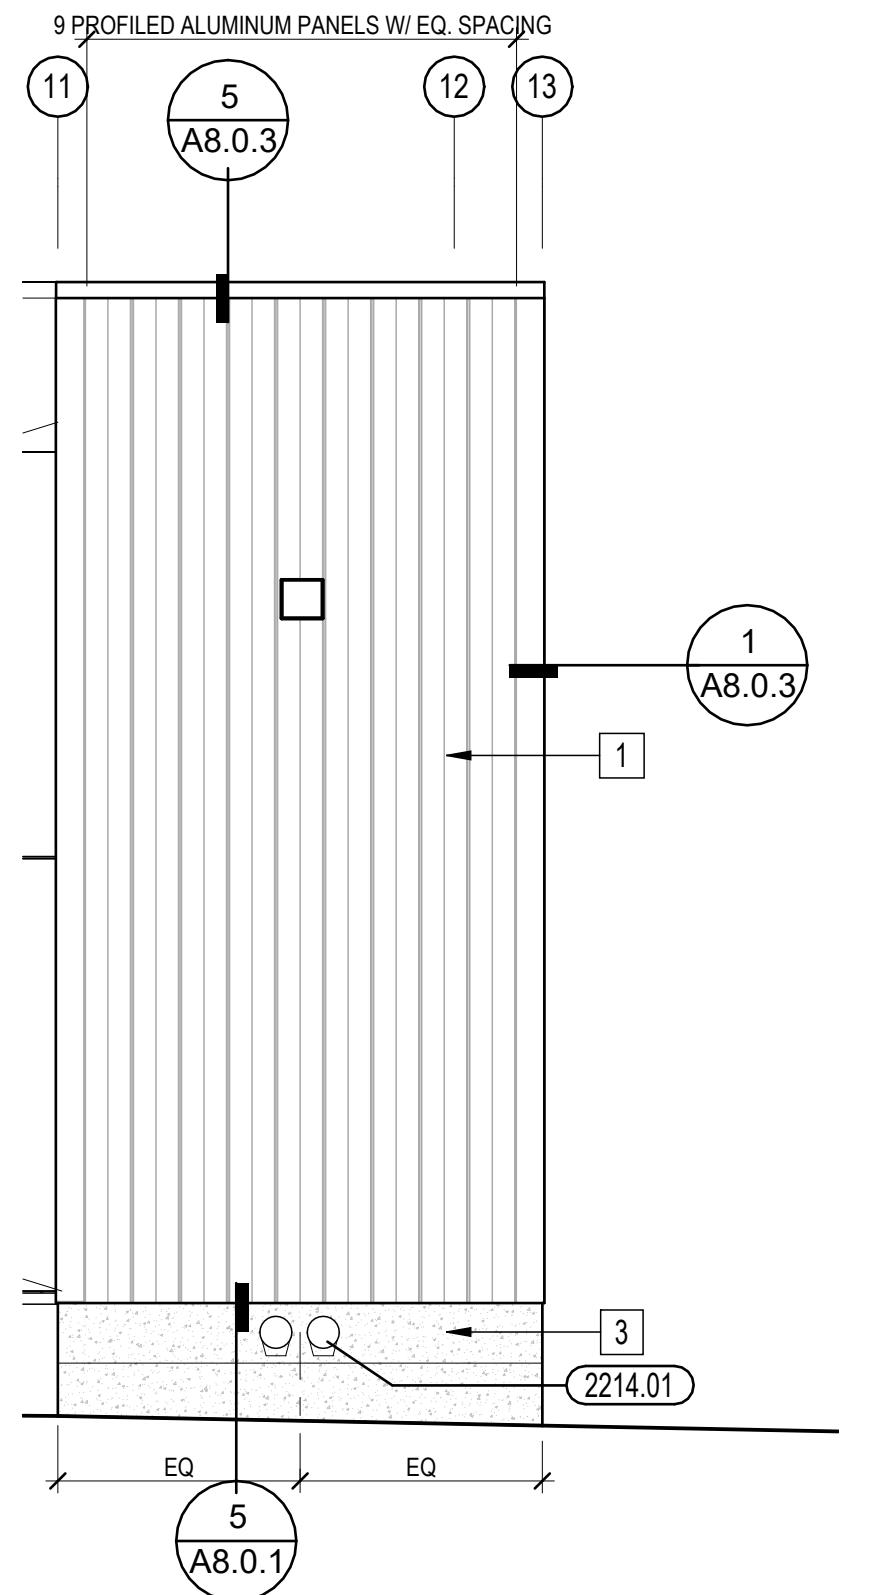


4 ENLARGED ELEVATION - DRIVE AISLE (WEST) - B
1/4" = 1'-0"

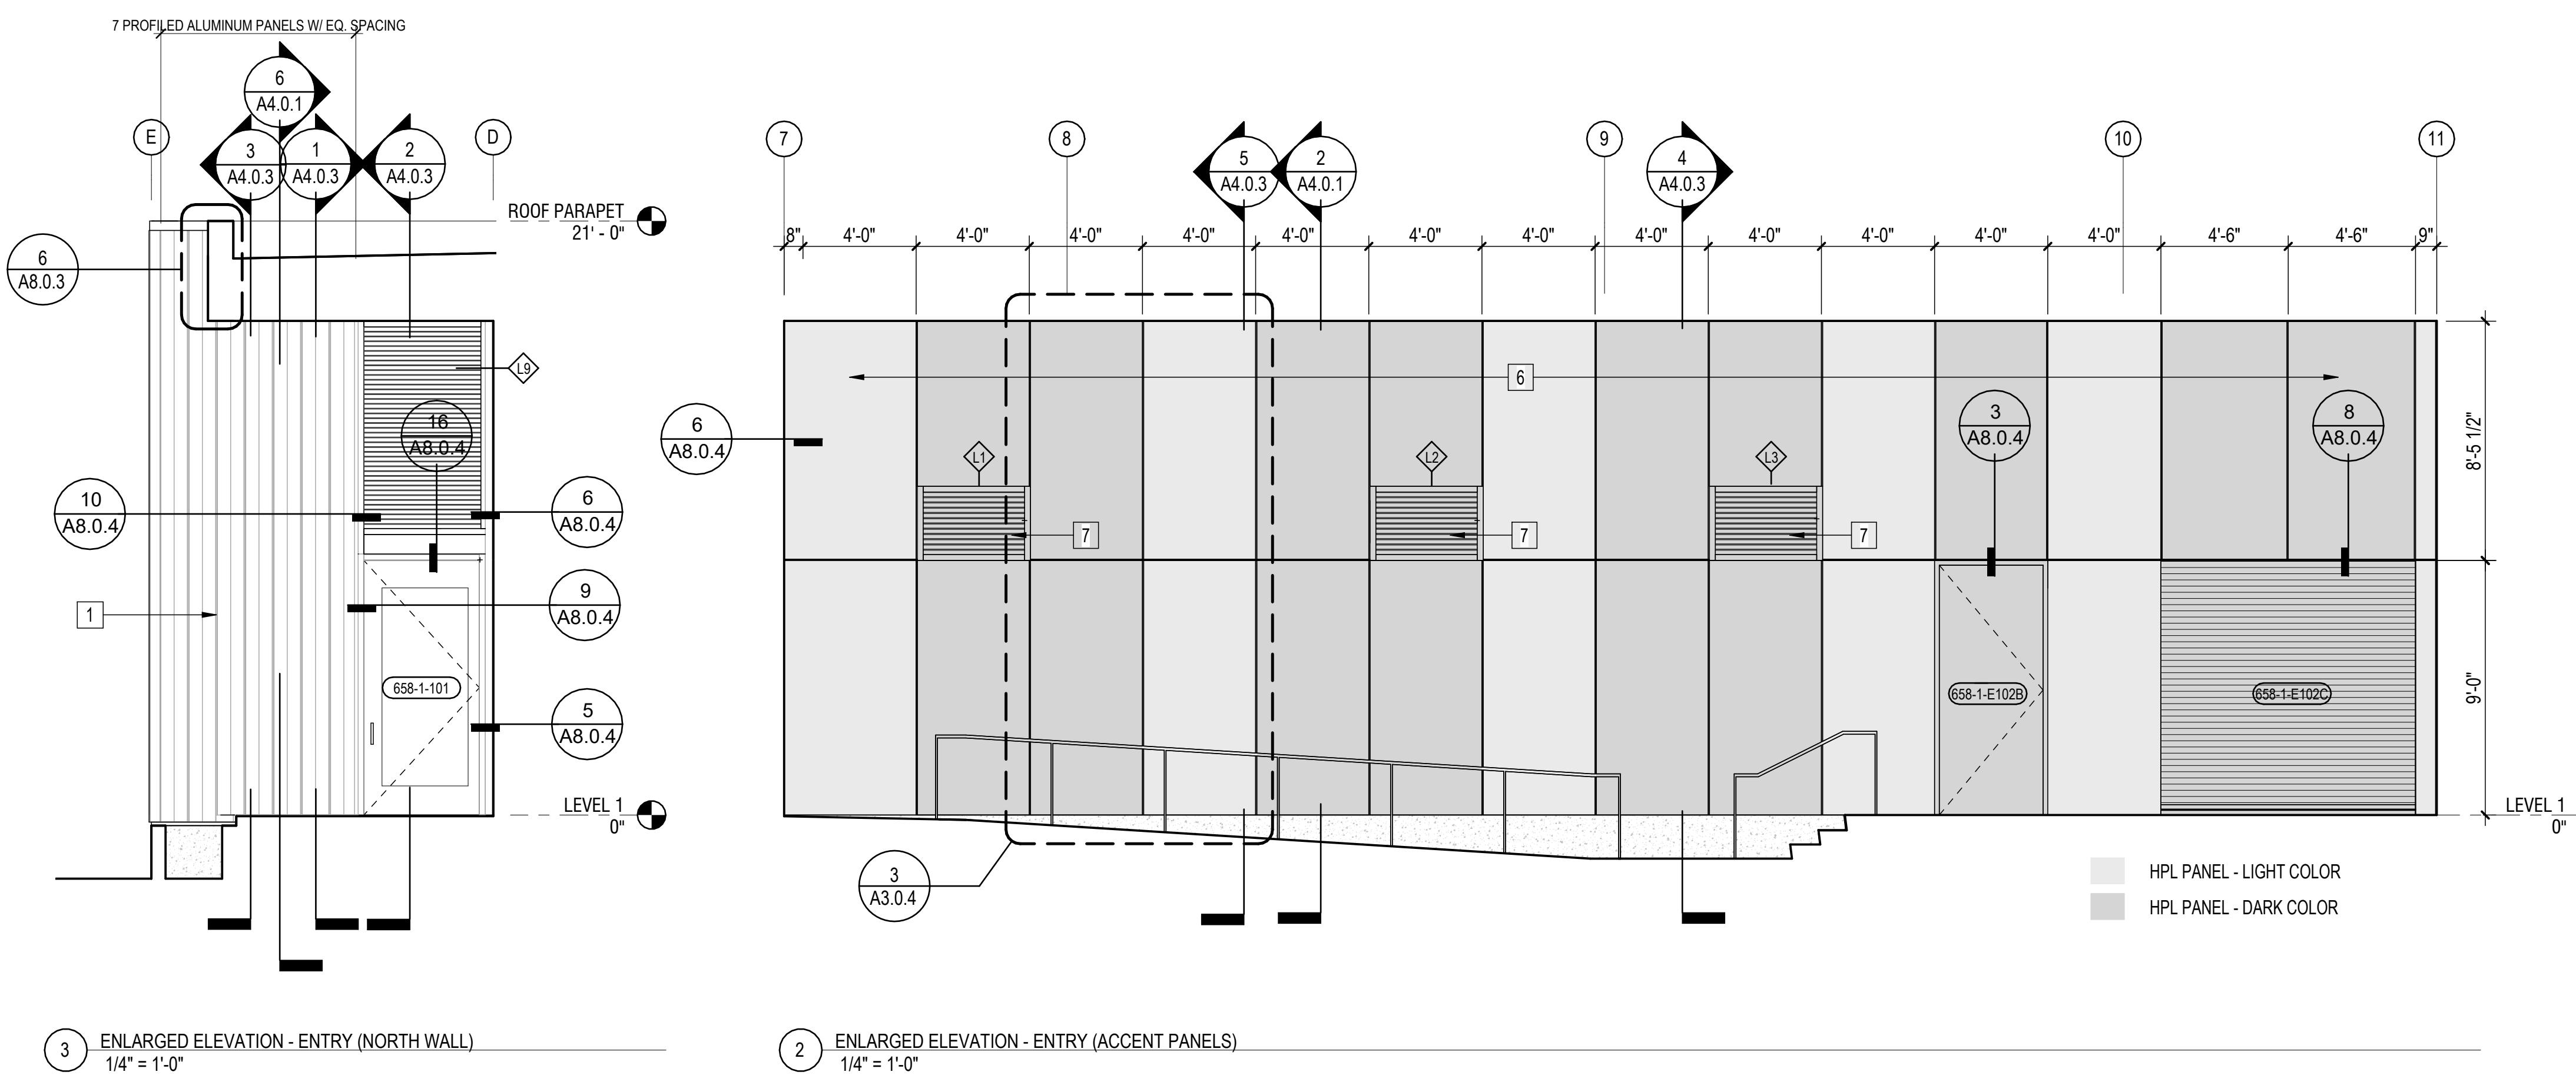


3 ENLARGED ELEVATION - ENTRY (NORTH WALL)
1/4" = 1'-0"

2 ENLARGED ELEVATION - ENTRY (ACCENT PANELS)
1/4" = 1'-0"

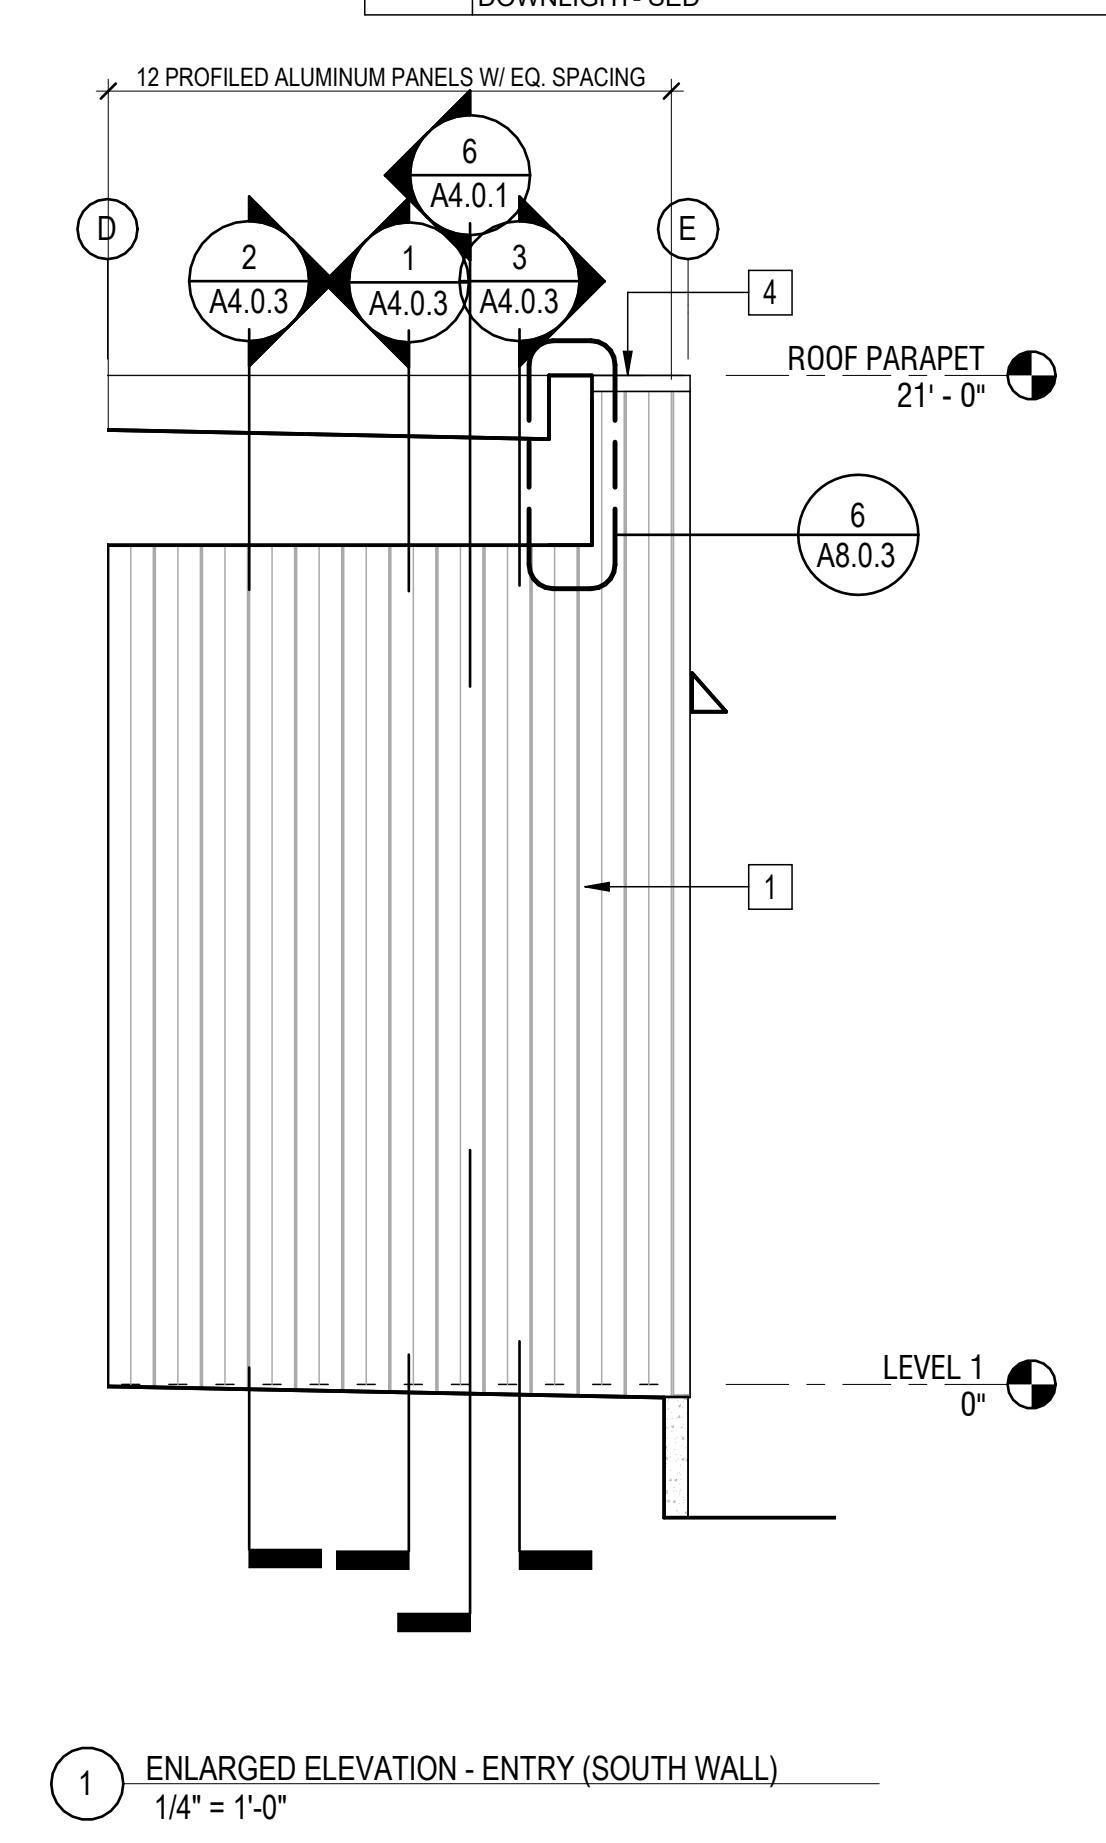

1 ENLARGED ELEVATION - ENTRY (SOUTH WALL)
1/4" = 1'-0"

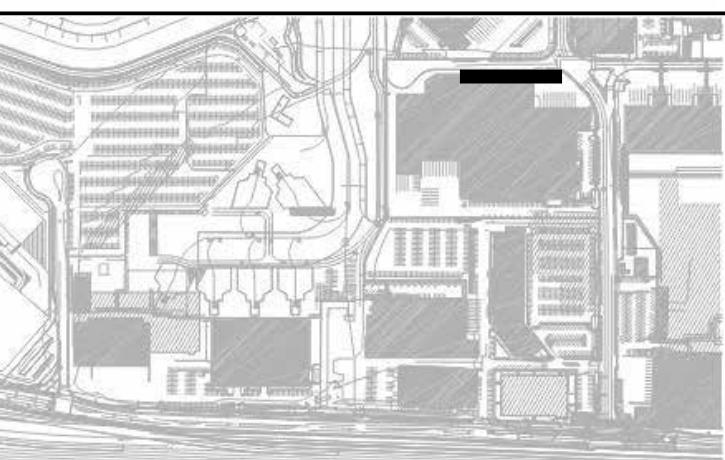

EXTERIOR ELEVATION GENERAL NOTES

NOTE 1.01

AIL

1 SIM — DWG NUMBER
A101 — REFERENCE LABEL

1 A101 — SHEET NUMBER

R TYP. WINDOW SILL HEIGHTS. SILL
IGHTS NOTED ON EXTERIOR ELEVATIONS
E EXCEPTIONS.

This architectural cross-section diagram illustrates the building's structure from LEVEL 1 to ROOF PARAPET. The diagram shows a series of vertical columns and beams, with various components and labels indicating specific details:

- Dimensions:** The total width of the building section is 31' - 9 3/8". The left portion is 14' - 9 1/2".
- Vertical Levels:** The levels are labeled from bottom to top: LEVEL 1, ROOF PARAPET, and ROOF.
- Key Components:**
 - Vertical columns are labeled with numbers 1 through 12, each with a specific material and thickness specification (e.g., 2 A8.0.3, 3 A4.0.1, 4 A4.0.1, 5, 6, 7, 11 A8.0.3, 12 A8.0.3).
 - Horizontal beams are labeled with numbers 1 through 7.
 - Brackets labeled "EQ" are positioned at the top of columns 4 and 5.
 - A small rectangular label "2656" is located near the center of the structure.
 - Callouts with numbers 1, 3, 5, and 7 point to specific features on the right side.
- Annotations:** A small circle with a diagonal line is located on the left side of the diagram.

2 ENLARGED EAST ELEVATION B - WEST CARGO ROAD
1/4" = 1'-0"

27 PROFILED ALUMINUM PANELS W/ EQ. SPACING

15 PROFILED ALUMINUM PANELS W/ EQ. SPACING

15 PROFILED ALUMINUM PANELS W/ EQ. SPACING

ROOF PARAPET 21'-0"

LEVEL 1 0"

1 A8.0.3

1 A8.0.3

11 A8.0.3

3 A8.0.3

10 A8.0.3

2 A8.0.3

4 A4.0.3

9 A8.0.3

2 A4.0.1

5 A4.0.3

8 A8.0.3

7 A8.0.3

11 A8.0.3

2656

2656

5

5

5

1

3

1 A8.0.1

7 ALUMINUM LOUVER- POWDERCOAT FINISH

KEYNOTE SCHEDULE

NOTE	DESCRIPTION
2656	EXTERIOR LIGHTING, WALL-MOUNTED WEDGE-TYPE DOWNLIGHT- SED

LEVEL 1

3 HPL PANELS - TYPICAL FASTENER LAYOUT

11921.66

FIELD UTILITIES AND PAVING

- STATION BP


EXTERIOR ELEVATIONS -

ENLARGED

PROJECT TITLE WES	SHEET TITLE E
SEAL	CONSULTANT'S LOGO PTA

The logo for the Pennsylvania Testing Authority (PTA) is displayed. It features a large, bold, grey 'PTA' monogram. To the left of the monogram, a circular emblem is partially visible, containing the words 'ARCHITECT' and 'ENGINEER' and a star symbol.

A3.0.4

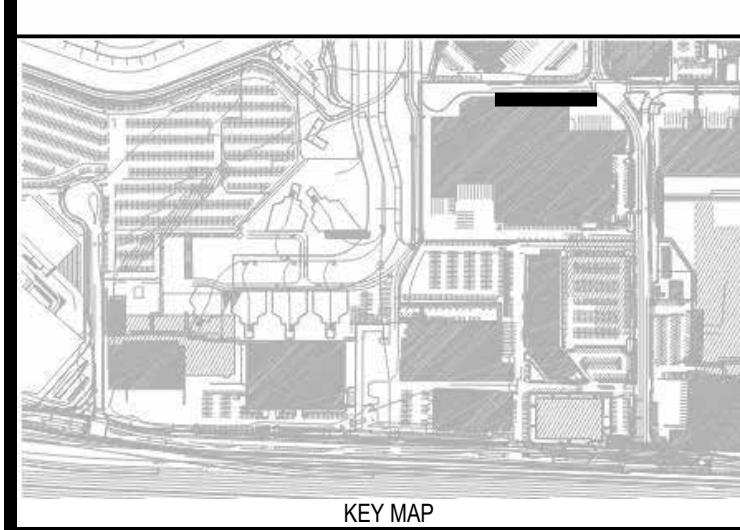

REVISIONS	BY
NO DATE	DESCRIPTION

CONTRACT NO.	PROJECT TITLE	CONSULTANT'S LOGO
11921.66 WEST FIELD UTILITIES AND PAVING - STATION BP		PTA
SHEET TITLE		


DESIGNED BY: JT	CHECKED BY: JT
DRAWN BY: JT	DATE: 01/26/2026
SCALE: AS NOTED	SIZE: ARCH-D
SHEET NUMBER	
A4.0.1	
REVISION	OF

KEYNOTE SCHEDULE	
NOTE	DESCRIPTION
0512	STRUCTURAL STEEL WITH HIGH-PERFORMANCE COATING- SSD
0550.01	GALVANIZED STEEL ROOF MAINTENANCE TIE-BACK ANCHOR, FLASHED INTO ROOF MEMBRANE- SAD, SSD
0551	WALL-MOUNTED STEEL LADDER WITH REQUIRED BLOCKING IN WALL
0754.01	TPO SINGLE-PLY MEMBRANE ROOFING, 60 MIL, SRI 85 MINIMUM
0772	ROOF ACCESS HATCH WITH INTEGRAL CURB, POWDERCOAT ALUMINUM
0833	STEEL OVERHEAD COILING DOOR, POWDERCOAT FINISH
0891	ALUMINUM LOUVER, WATER-RETURN TYPE, POWDERCOAT FINISH




SFO

**SAN FRANCISCO
INTERNATIONAL AIRPORT**

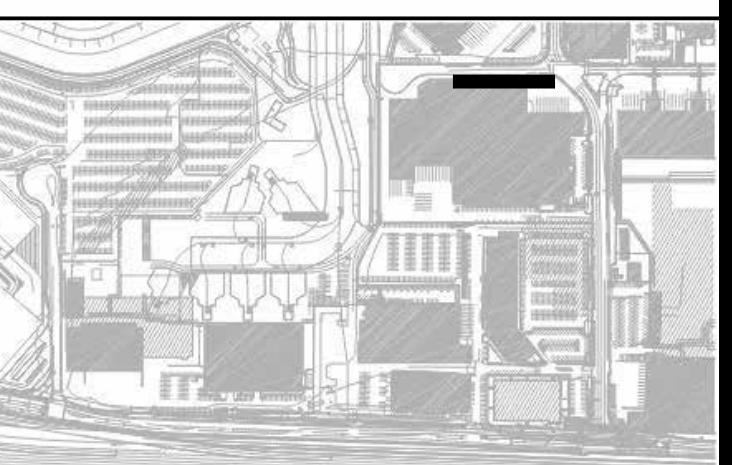

KEY MAP

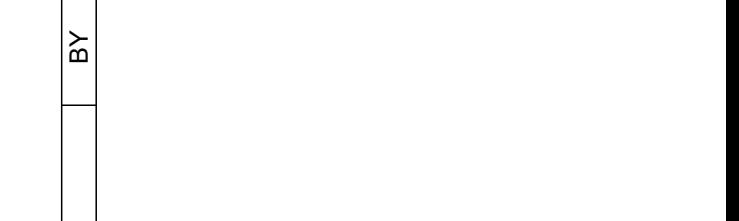

LEVEL 1 0"

REVISIONS
NO. DATE
DESCRIPTION

11921.66
WEST FIELD UTILITIES AND PAVING
- STATION BP

CONTRACT NO.
PROJECT TITLE
SHEET TITLE
SEAL
CONSULTANT'S LOGO

**ENLARGED BUILDING
SECTIONS - LOADING DOCK**







PTA


DESIGNED BY:
JT
DRAWN BY:
JT
SCALE:
AS NOTED
SHEET NUMBER:
REVISION:

CHECKED BY:
JT
DATE:
01/26/2026
SIZE:
ARCH-D
A4.0.3
OF

NOTE: If this drawing is not on 24" x 36", it has been revised from its original size. Scales as noted on drawings / details are no longer applicable.

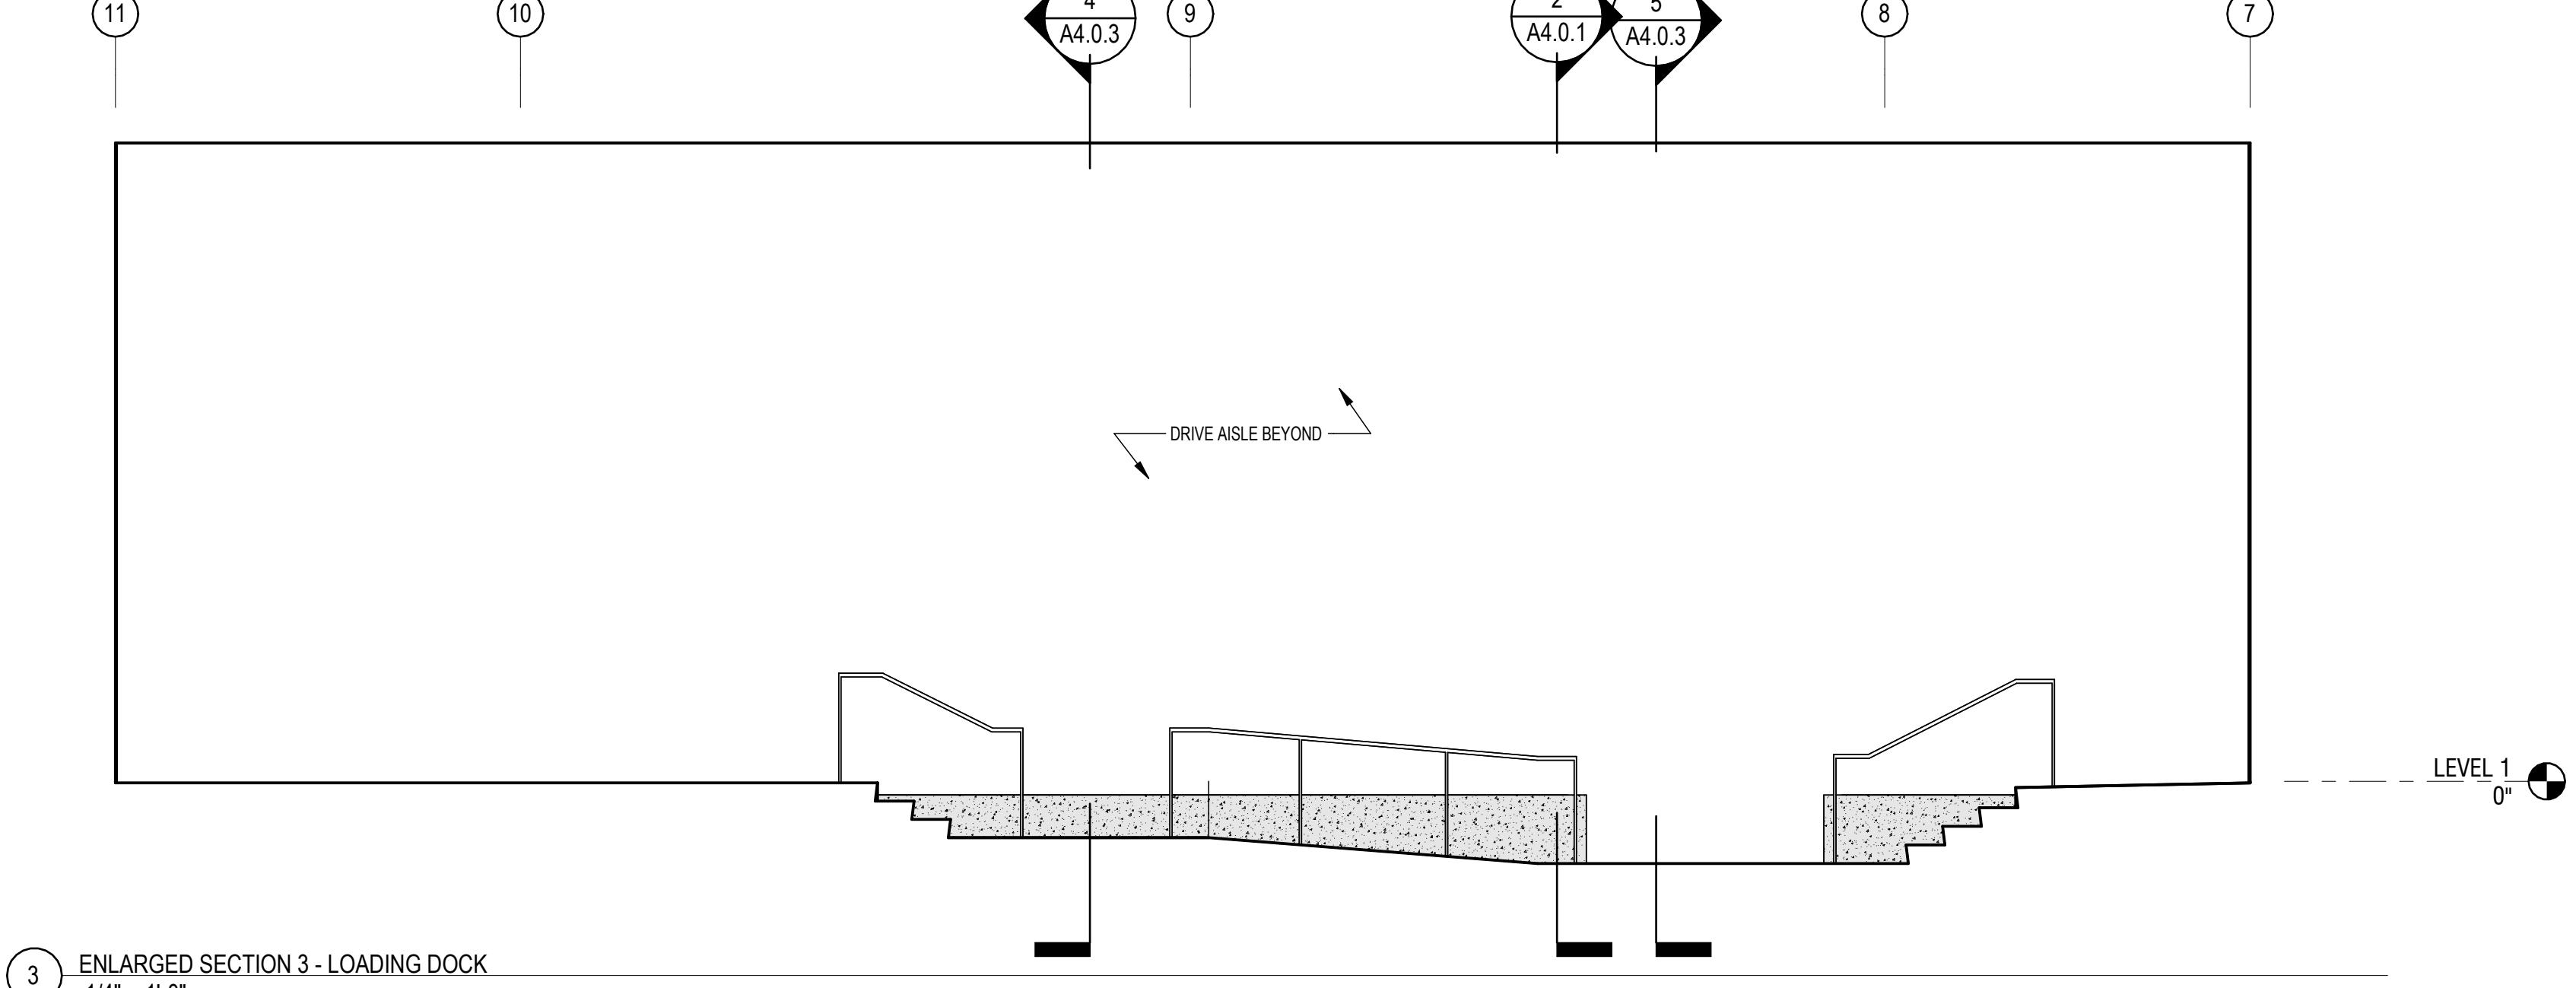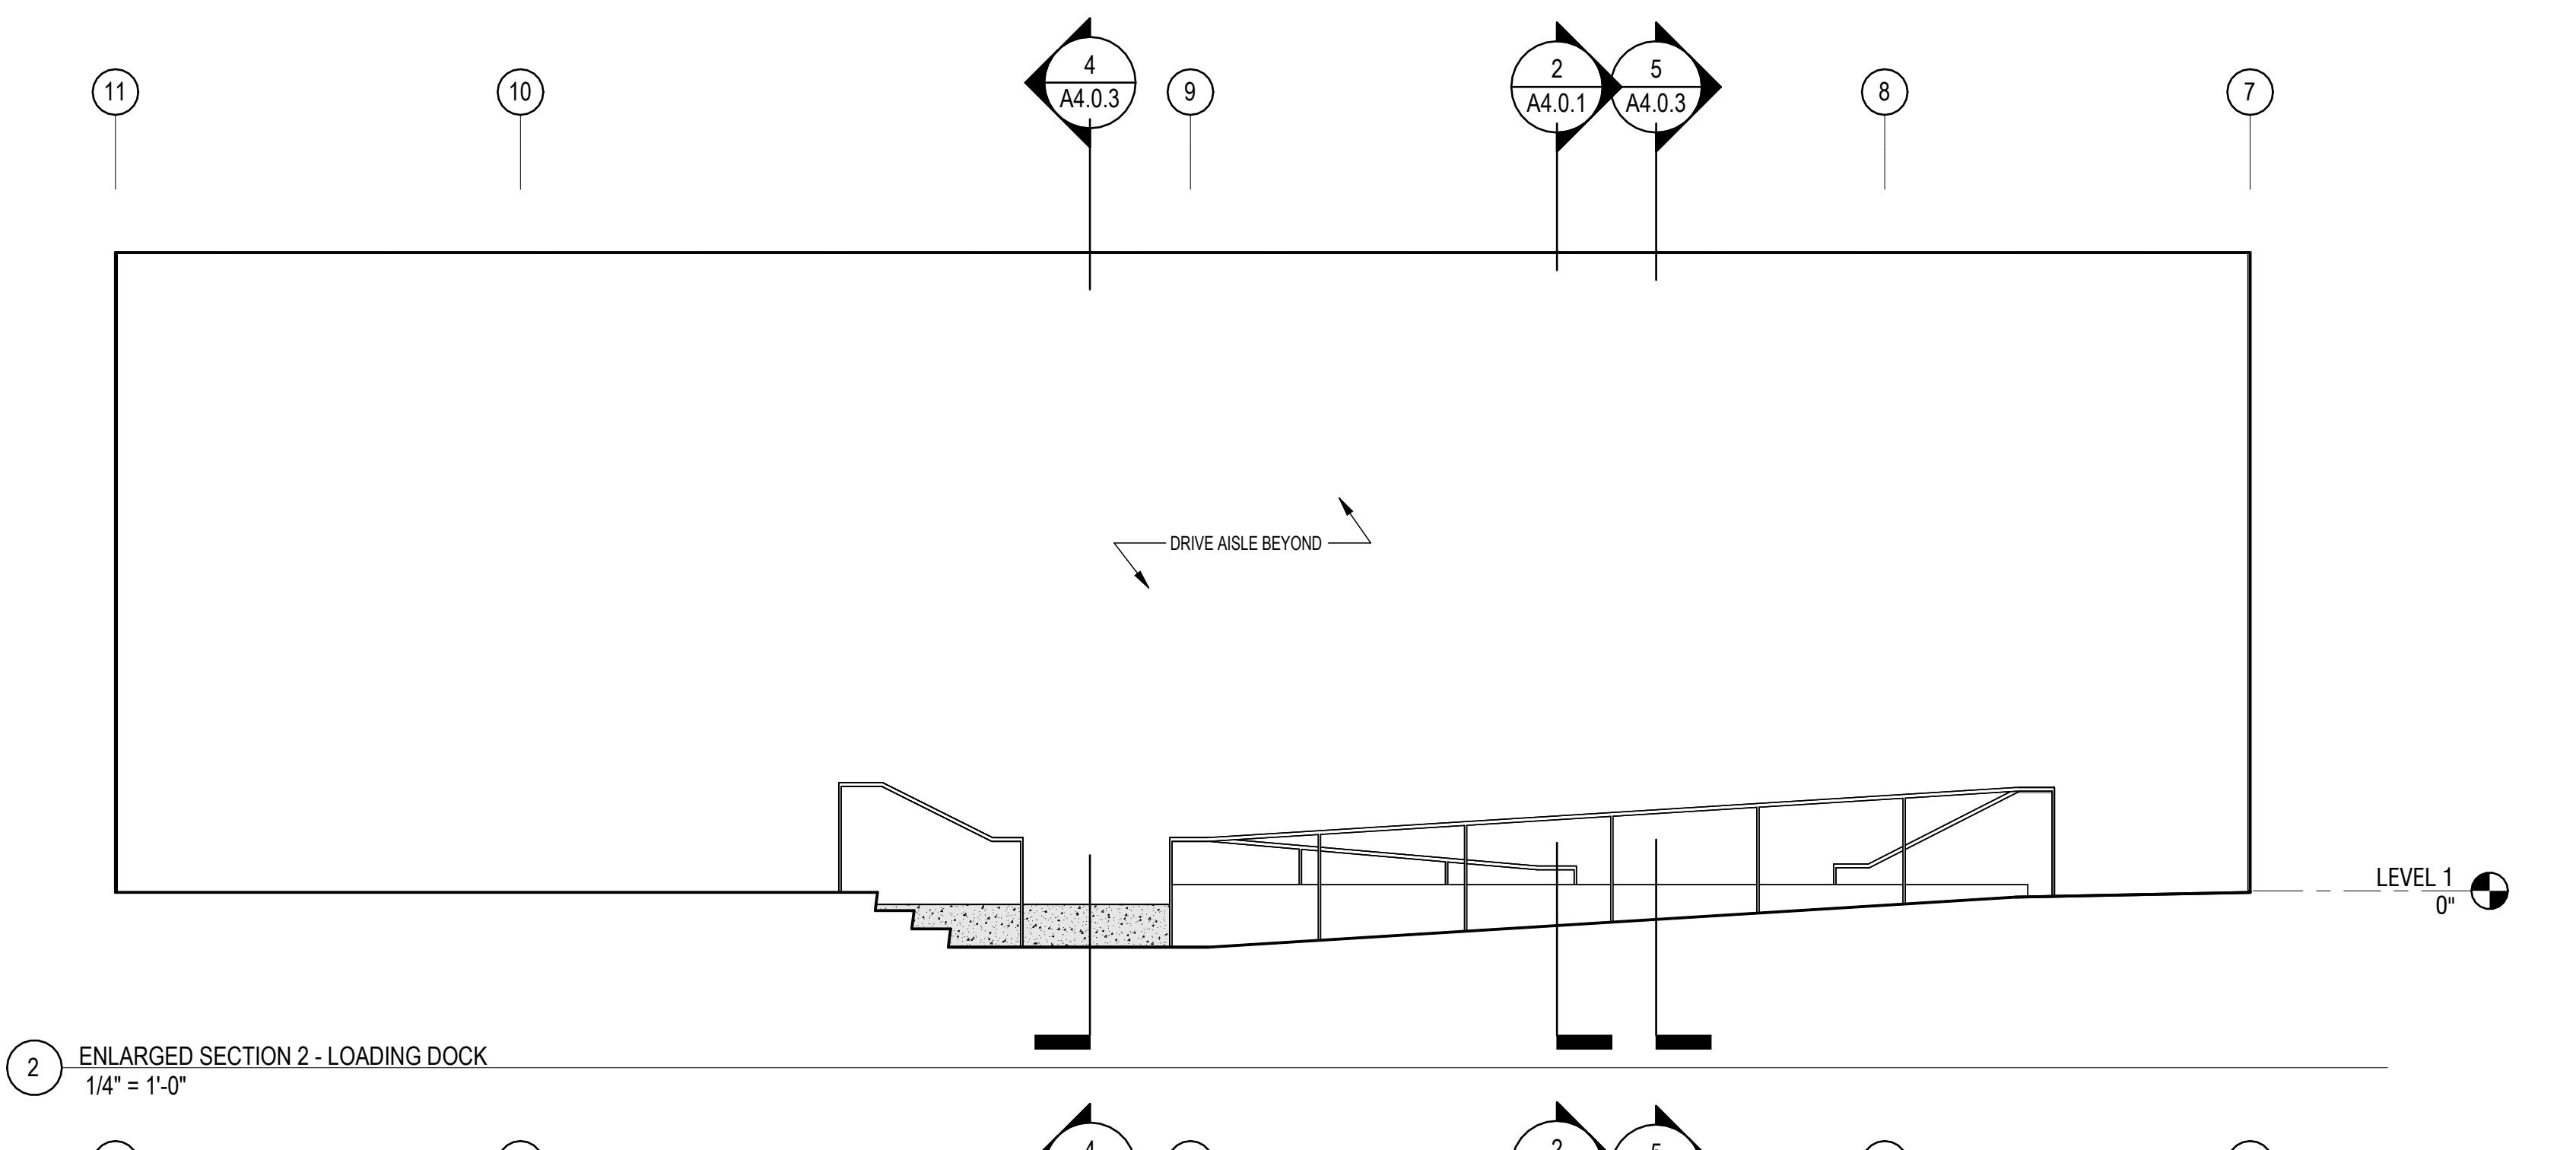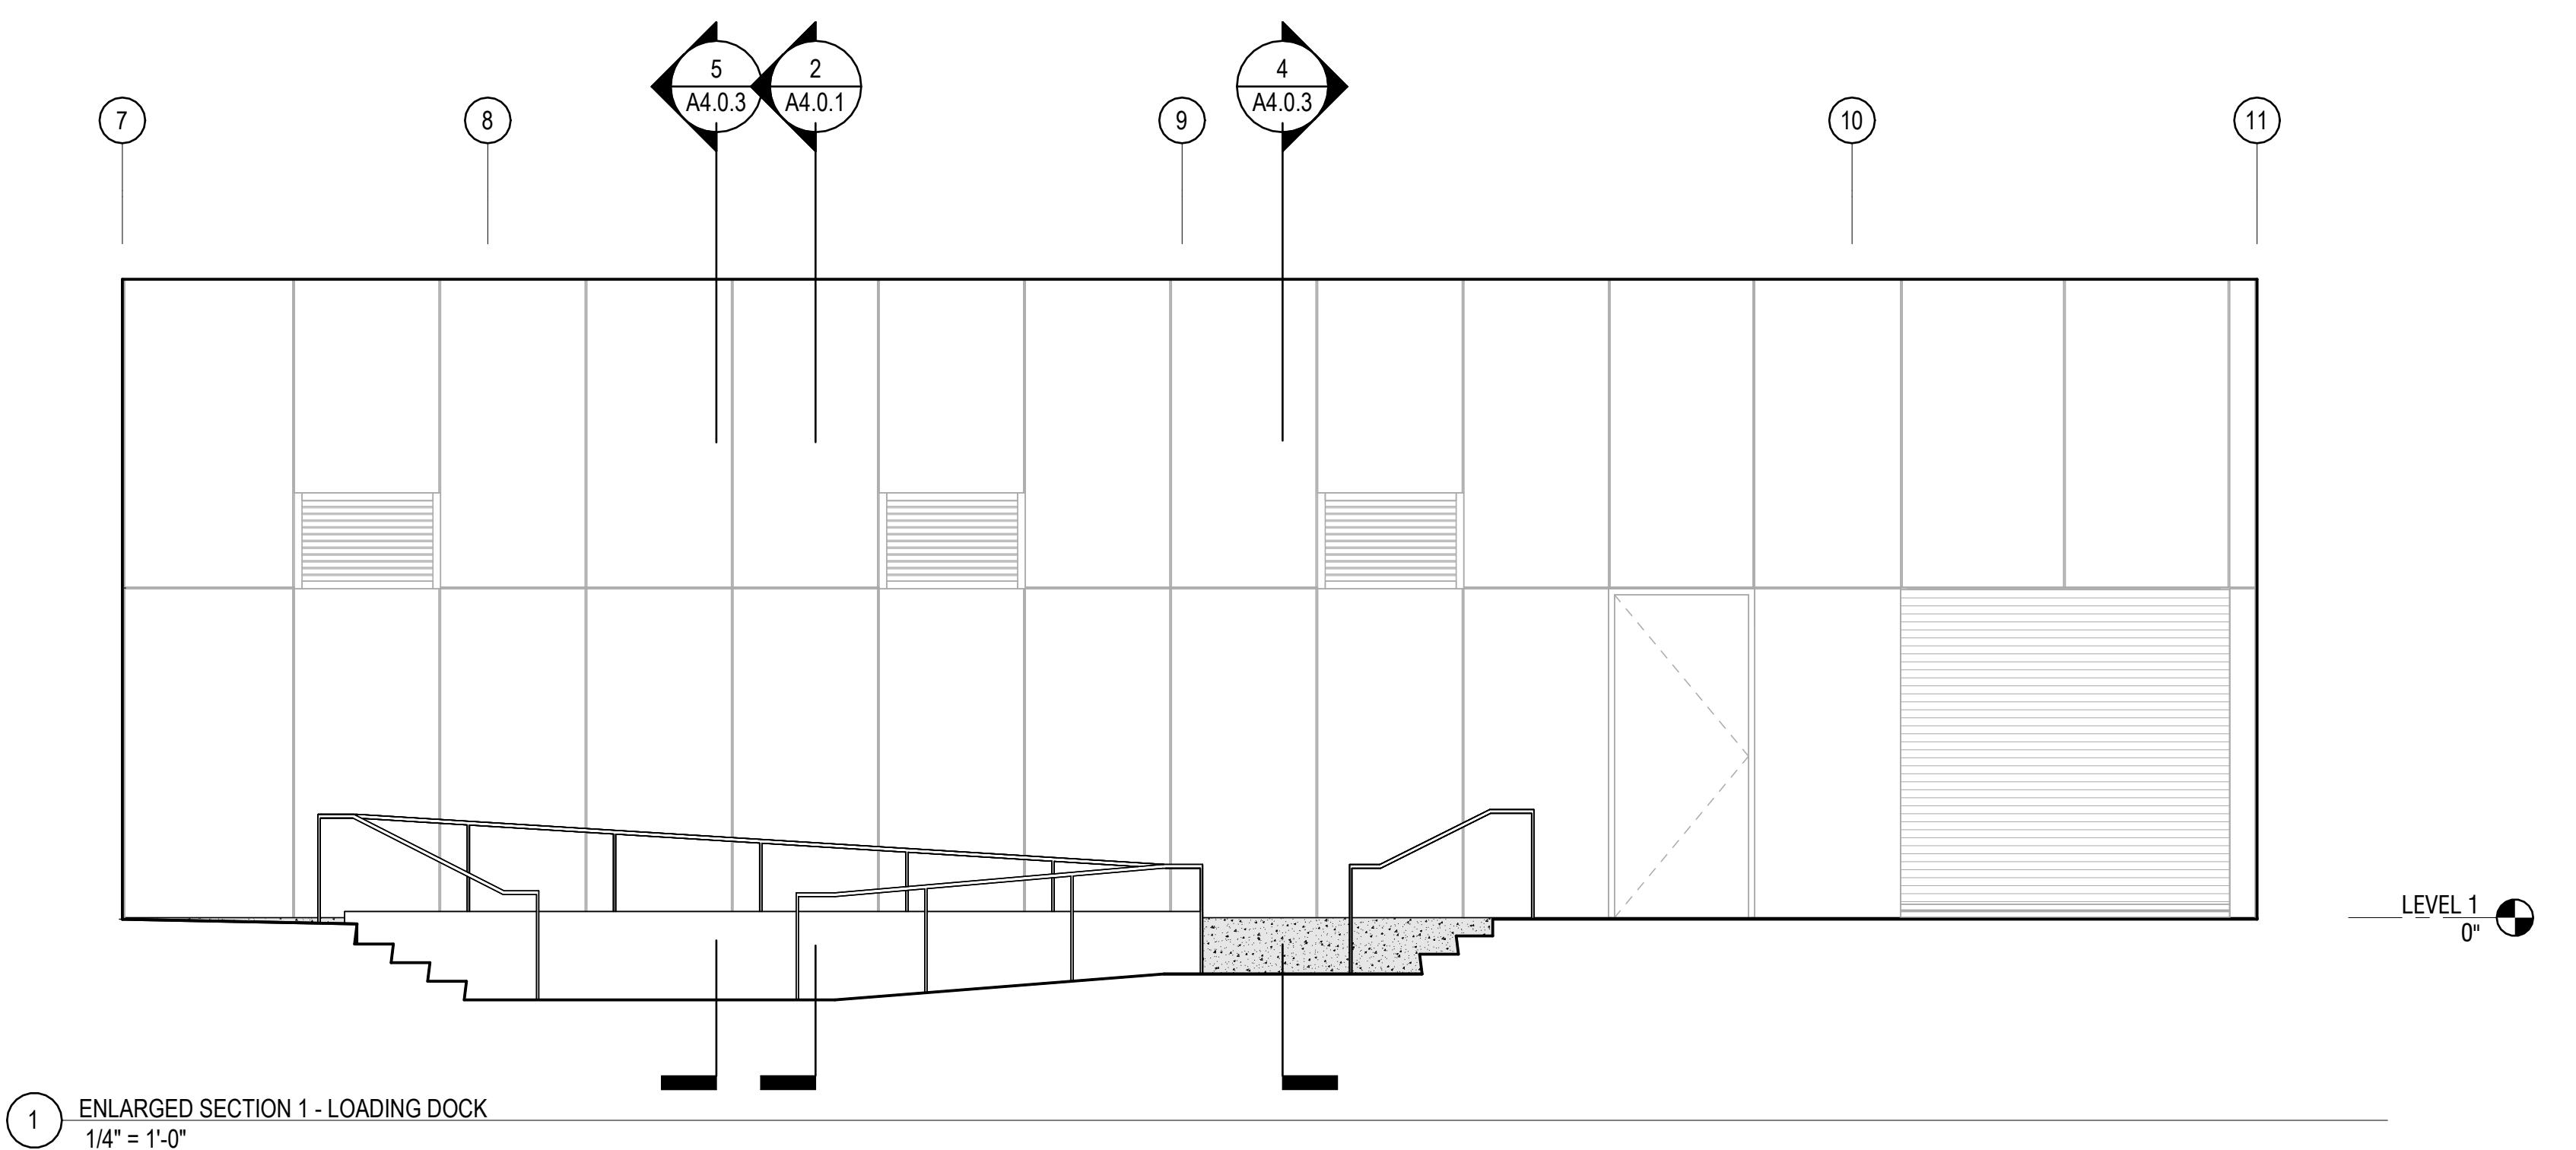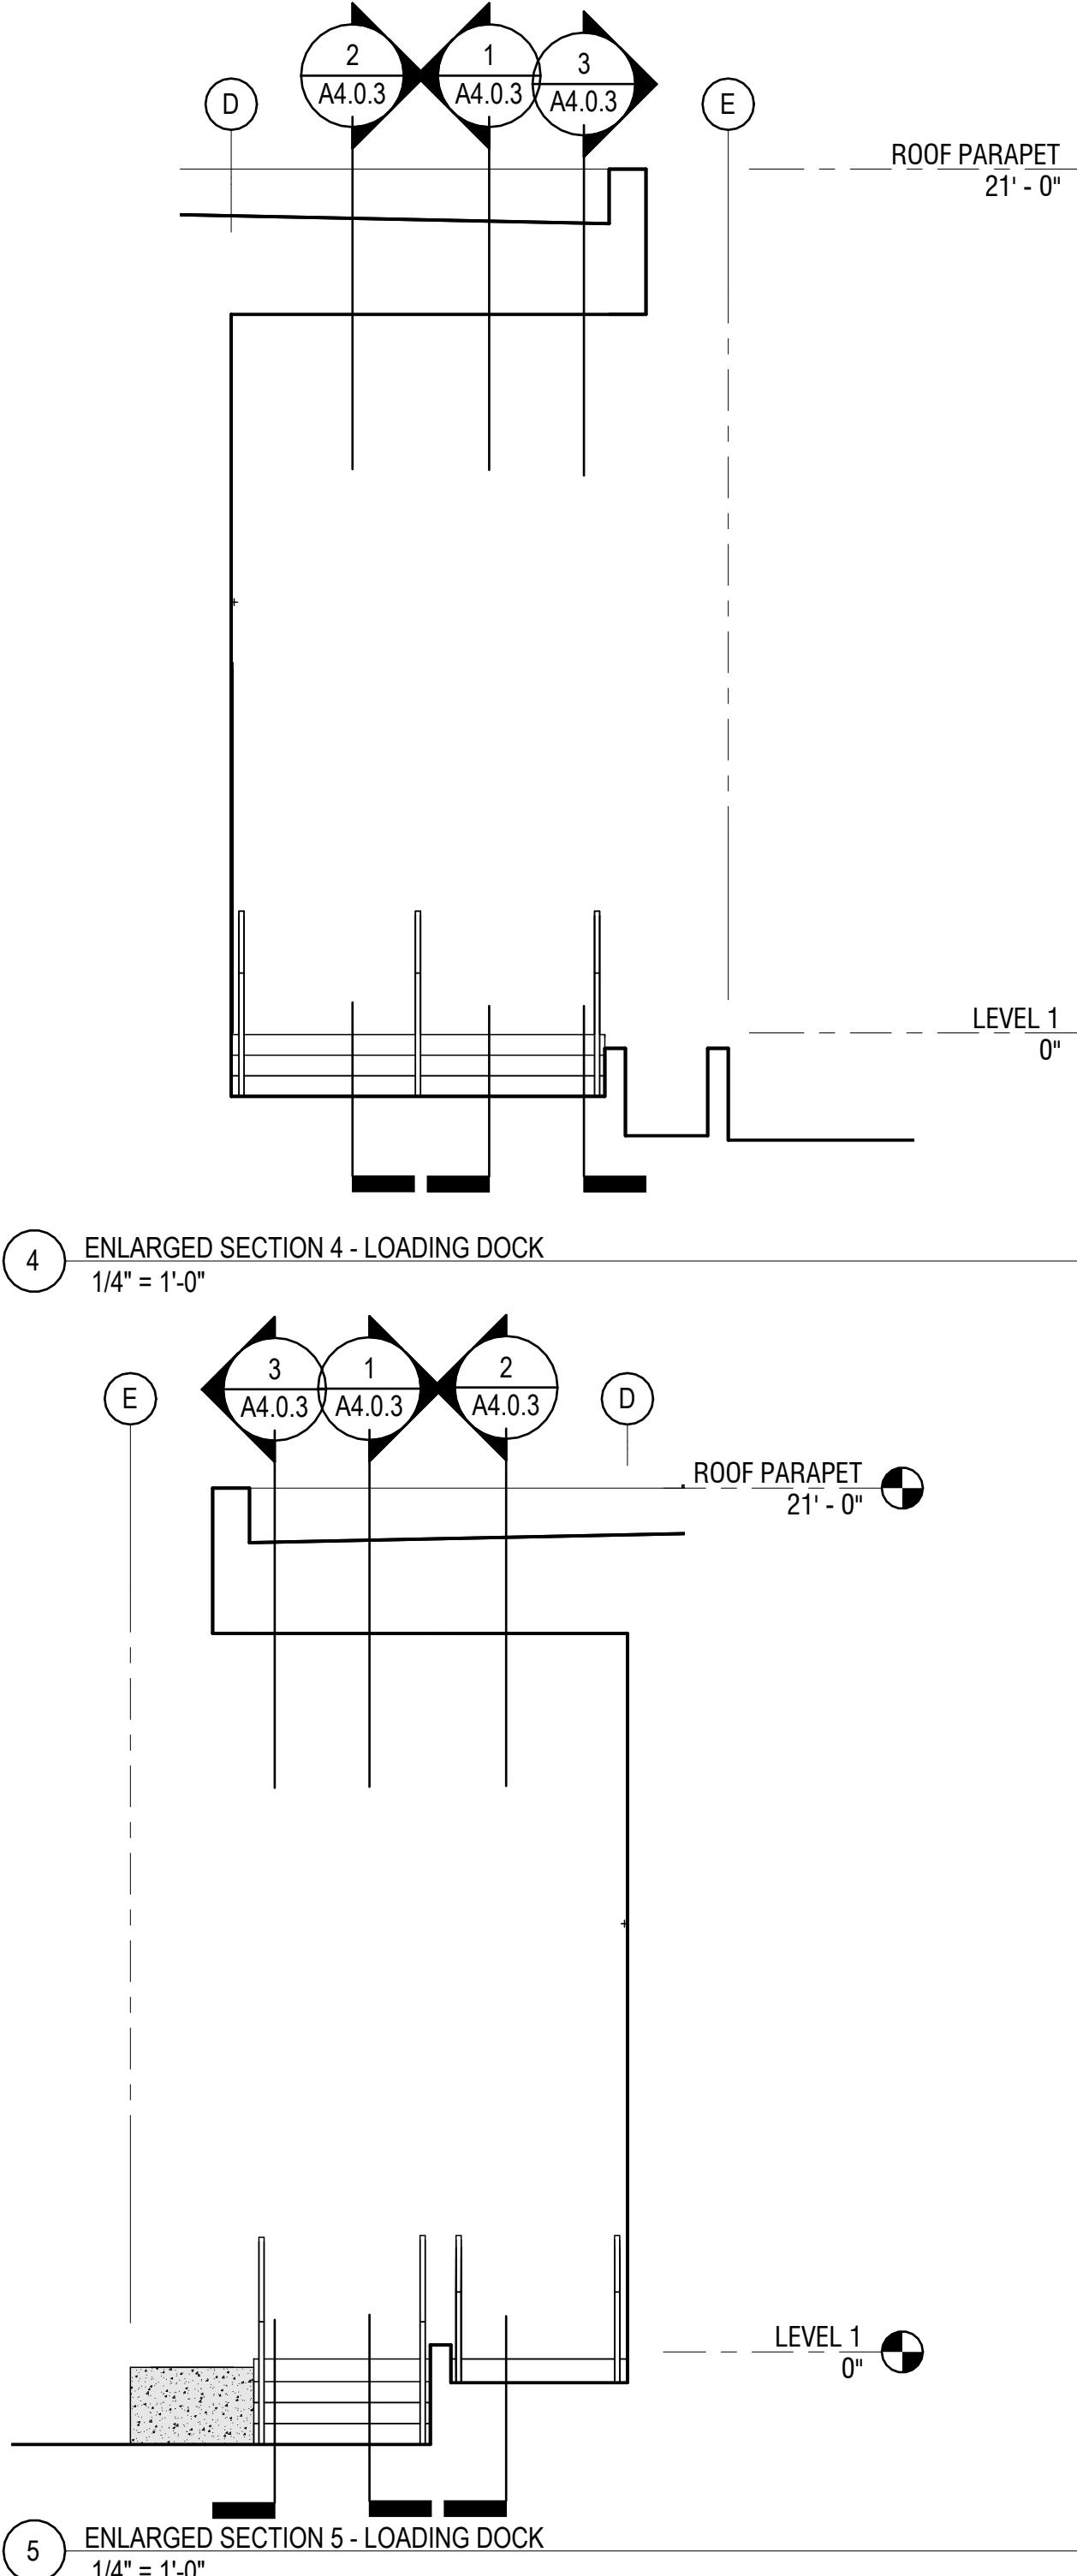

ENLARGED SECTION 3 - LOADING DOCK
1/4" = 1'-0"

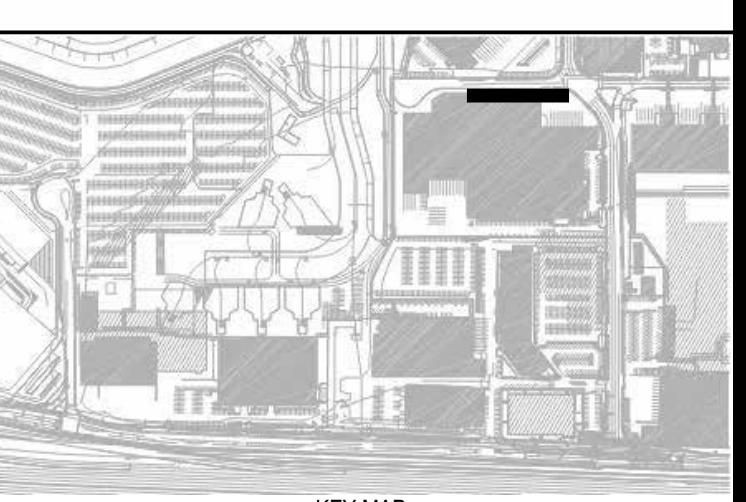


INTERIOR ELEVATIONS

REVISIONS	DESCRIPTION
NO DATE	

11921.66
- STATION BP

CONTRACT NO.	PROJECT TITLE	CONSULTANT'S LOGO
SEAL	PROJECT TITLE	CONSULTANT'S LOGO

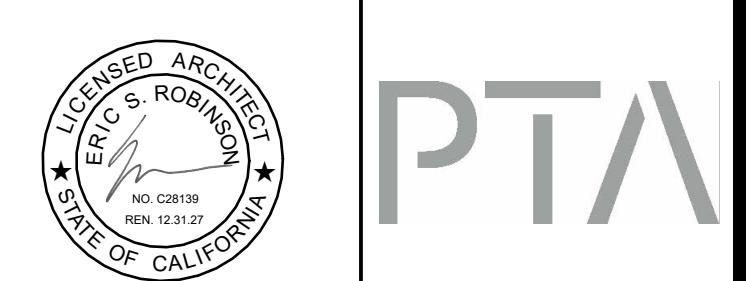

PTA

FINISH SCHEDULE	
GWB	5/8" GYPSUM BOARD, LEVEL 2 FINISH- PRIMED & PAINTED
EB1	INTEGRAL EPOXY WALL BASE, 4" H. REF. 09 6730
EB2	INTEGRAL EPOXY WALL BASE, 4" H. REF. 09 6720
VBI	VINYL WALL BASE (COVE BASE)
HPC	HIGH-PERFORMANCE COATING. REF. 09 9670

KEYNOTE SCHEDULE	
NOTE	DESCRIPTION
0512	STRUCTURAL STEEL WITH HIGH-PERFORMANCE COATING- SSD
0551	WALL-MOUNTED STEEL LADDER WITH REQUIRED BLOCKING IN WALL
0845	TRANSLUCENT POLYCARBONATE PANEL, 40MM THICKNESS
0891	ALUMINUM LOUVER, WATER-RETURN TYPE, POWDERCOAT FINISH

DESIGNED BY: JT	CHECKED BY: JT
DRAWN BY: XX	DATE: 01/26/2026
SCALE: AS NOTED	SIZE: ARCH-D
SHEET NUMBER	

REVISION	OF
----------	----

A6.0.1



KEY MAP

REVISIONS	DESCRIPTION

NO DATE	PROJECT TITLE	CONTRACT NO.	CONSULTANT'S LOGO
	WEST FIELD UTILITIES AND PAVING		PTA

**EXTERIOR DETAILS -
FOUNDATION - FOR
REFERENCE ONLY**

11921.66

- STATION BP

PROJECT TITLE

SEAL

CONTRACT NO.

CONSULTANT'S LOGO

PTA

LICENSED ARCHITECT

NO. 12310

REN. 12/31/2026

DESIGNED BY:

JT

DRAWN BY:

JT

SCALE:

AS NOTED

SIZE:

ARCH-D

SHEET NUMBER


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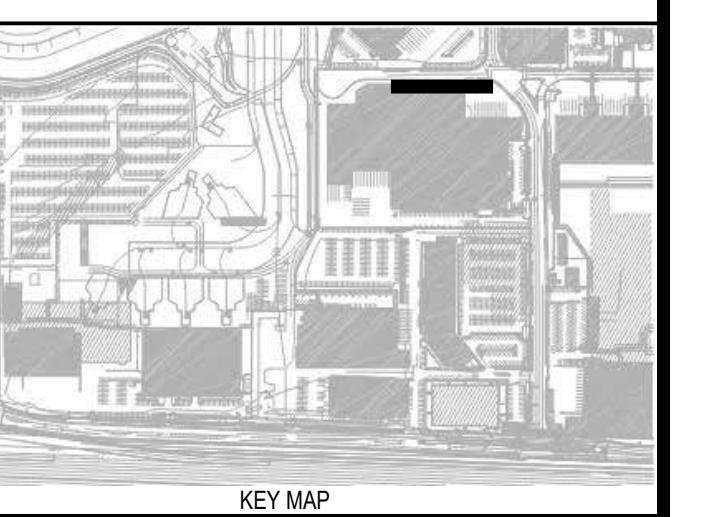
REVISION

42

OF


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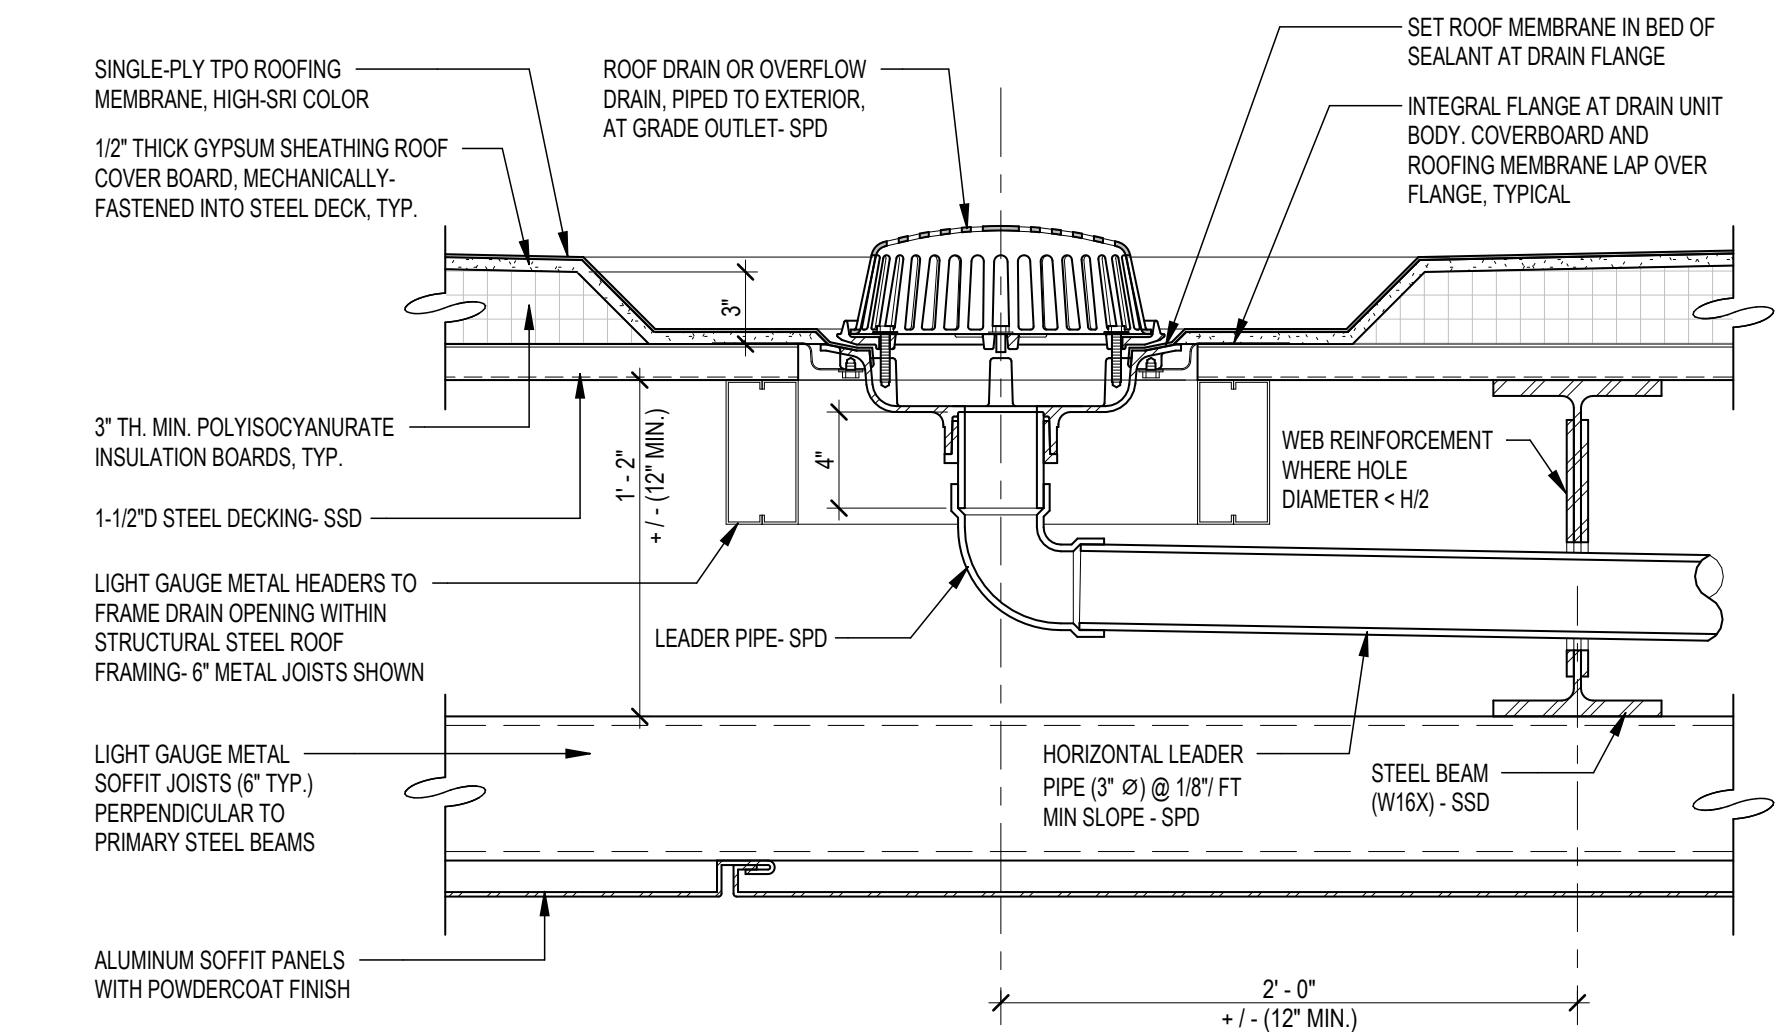


KEY MAP

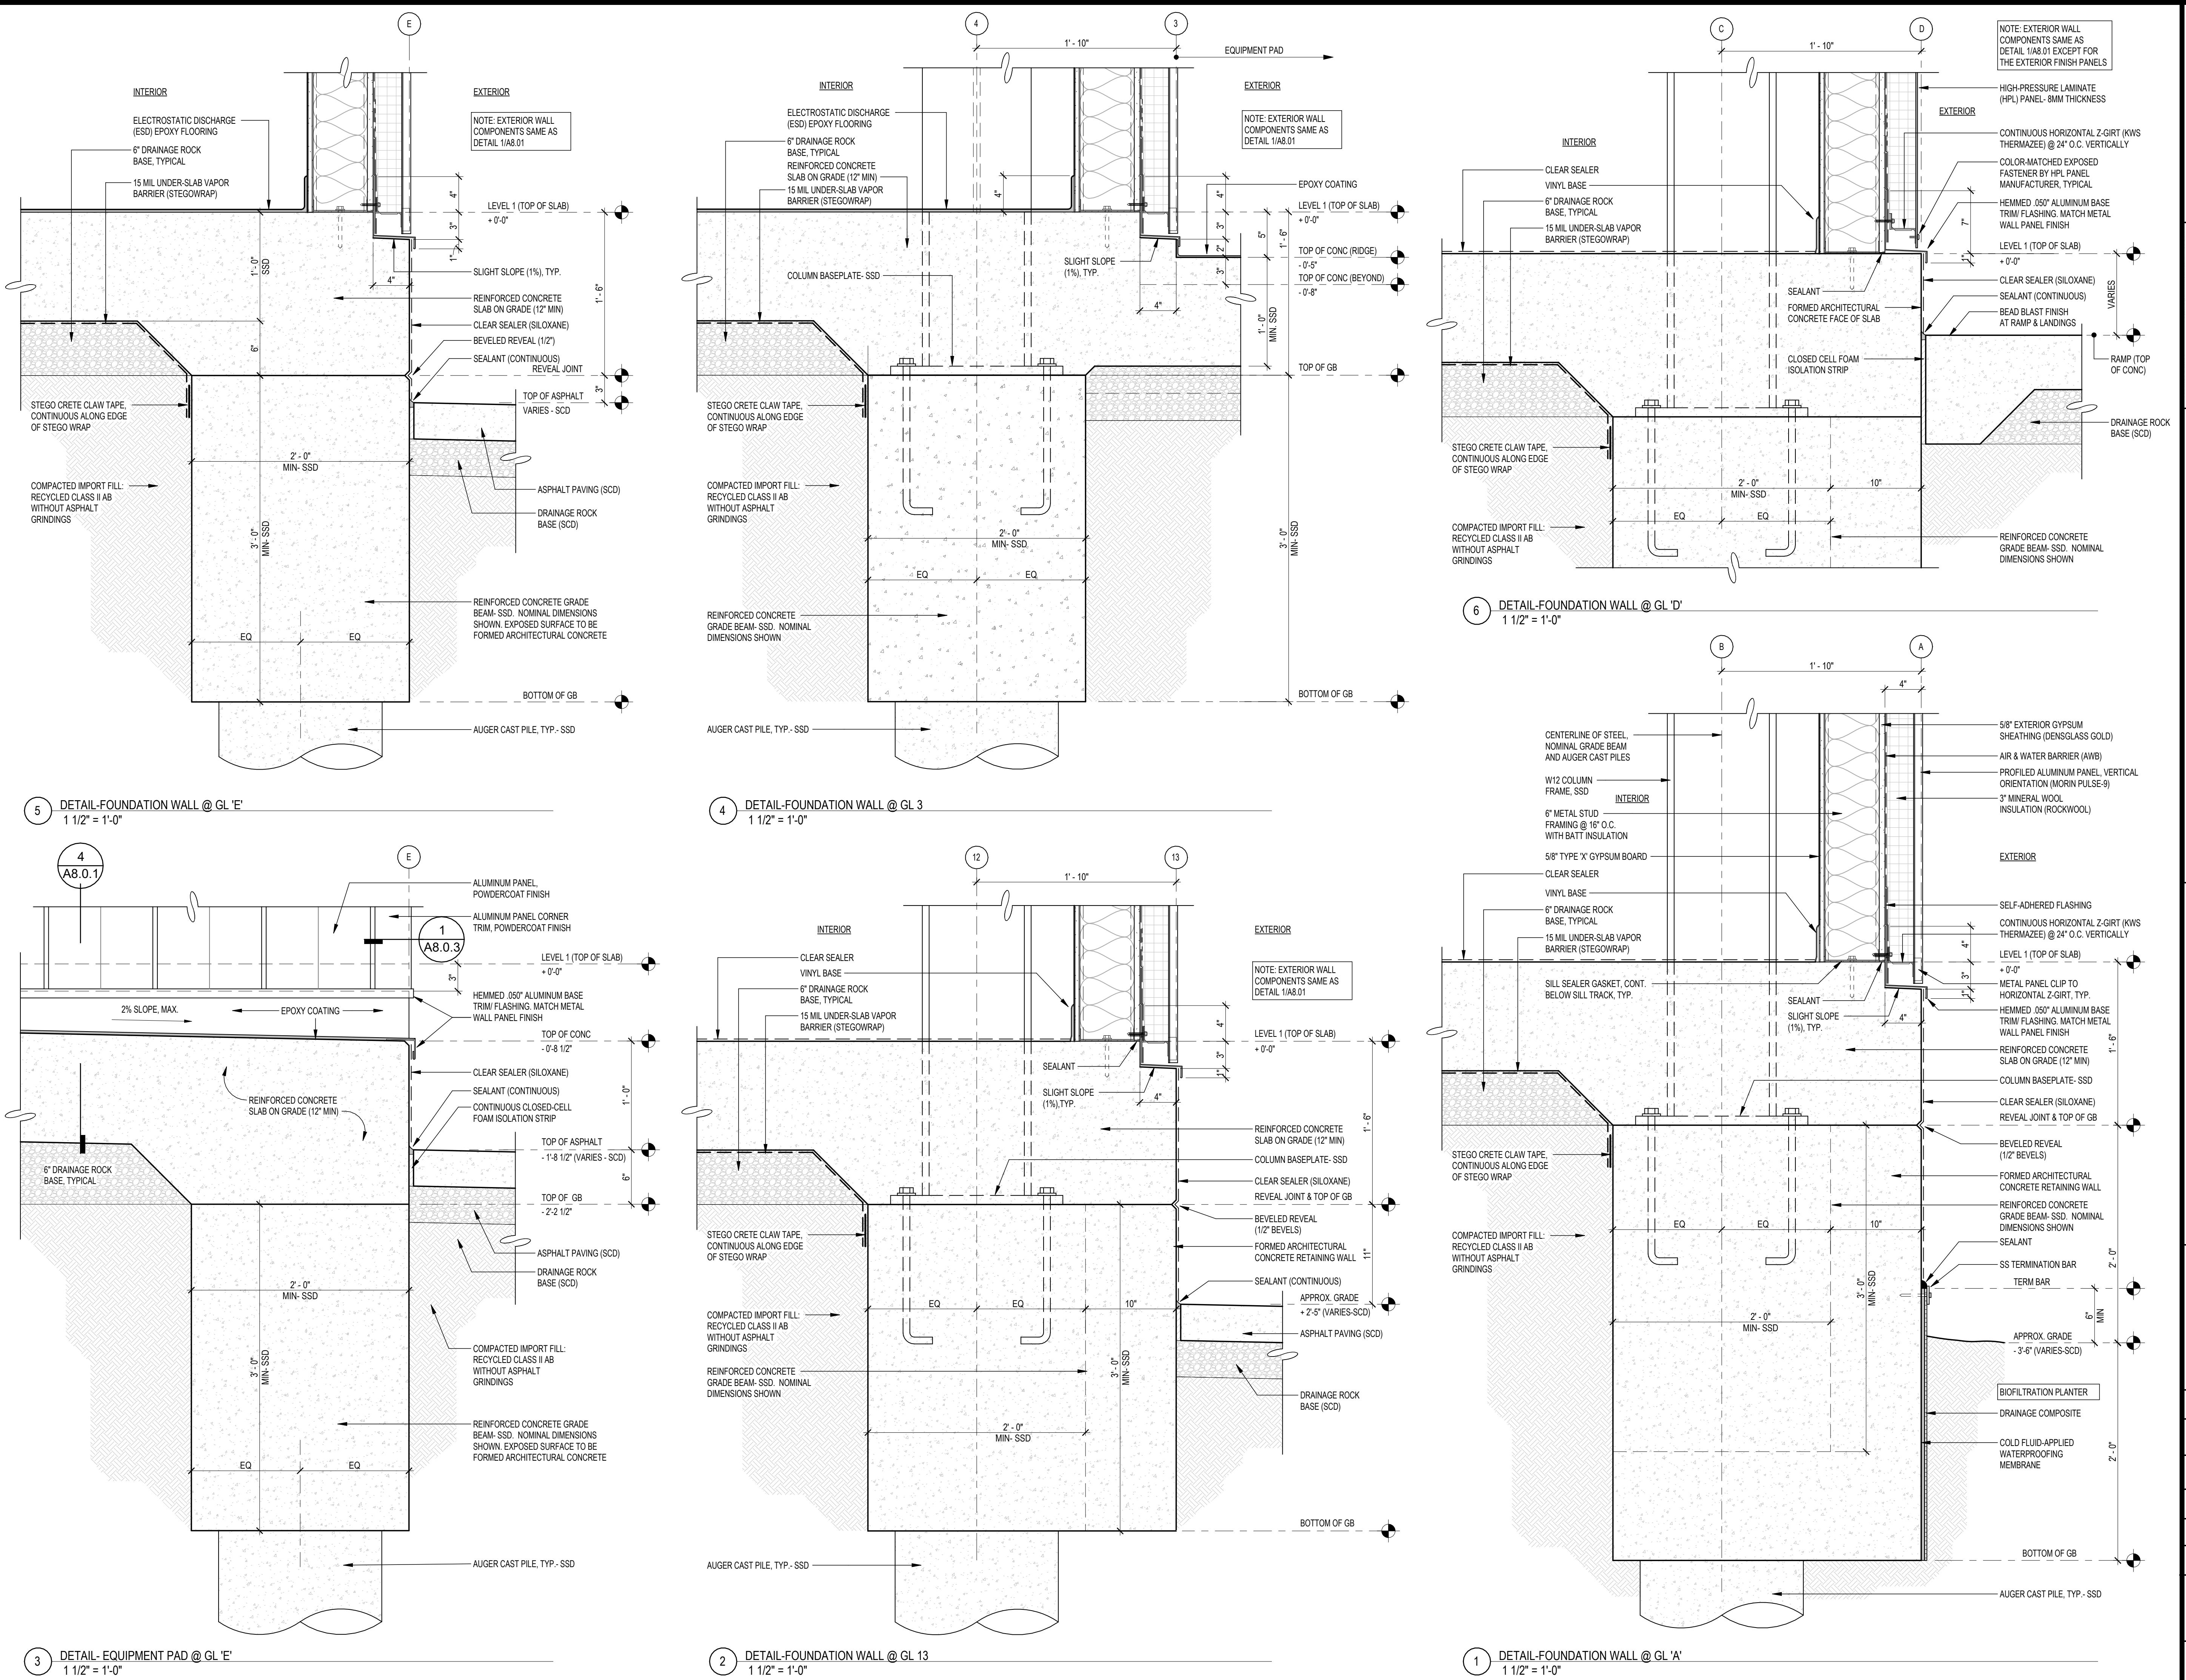
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NO DATE	
11921.66	
WEST FIELD UTILITIES AND PAVING - STATION BP	
CONTRACT NO.	PROJECT TITLE
SEAL	CONSULTANT'S LOGO
PTA	
DESIGNED BY: Designer	CHECKED BY: Checker
DRAWN BY: Author	DATE: 01/26/2026
SCALE: AS NOTED	SIZE: ARCH-D
SHEET NUMBER	
A8.0.5	
REVISION	
OF	




12 DETAIL-ROOF TIE-BACK ANCHOR
1 1/2" = 1'-0"

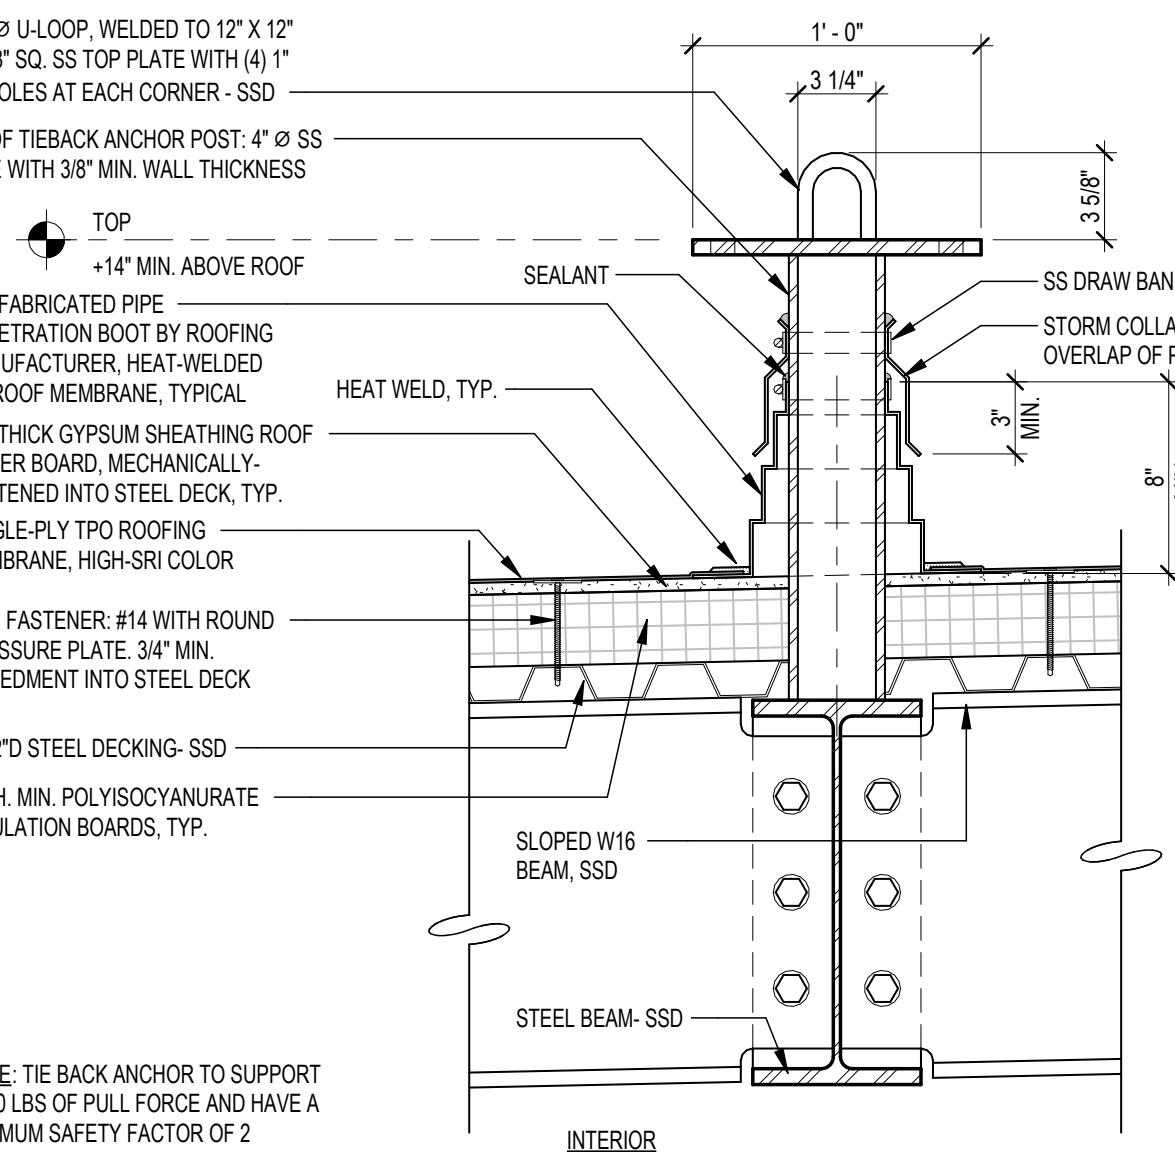


8 DETAIL-ROOF DRAIN & OVERFLOW (PORCH ROOF)
1 1/2" = 1'-0"

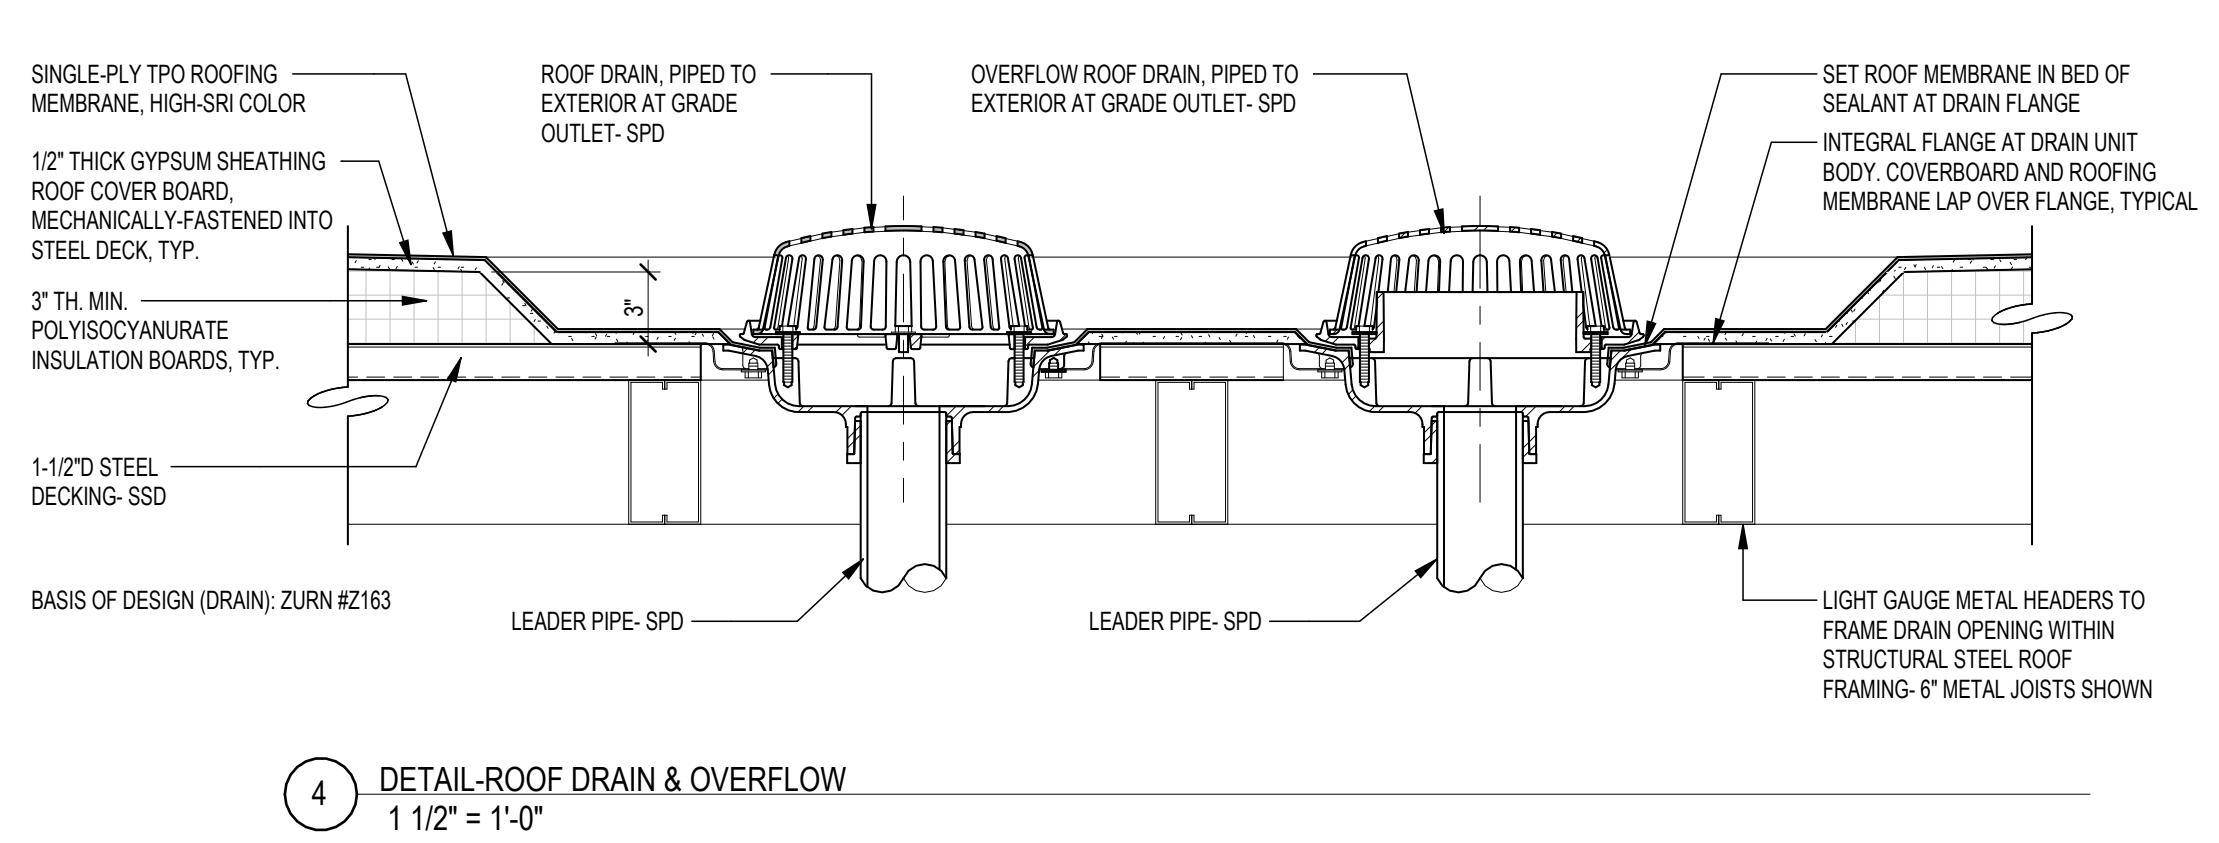


4 DETAIL-ROOF DRAIN & OVERFLOW
1 1/2" = 1'-0"

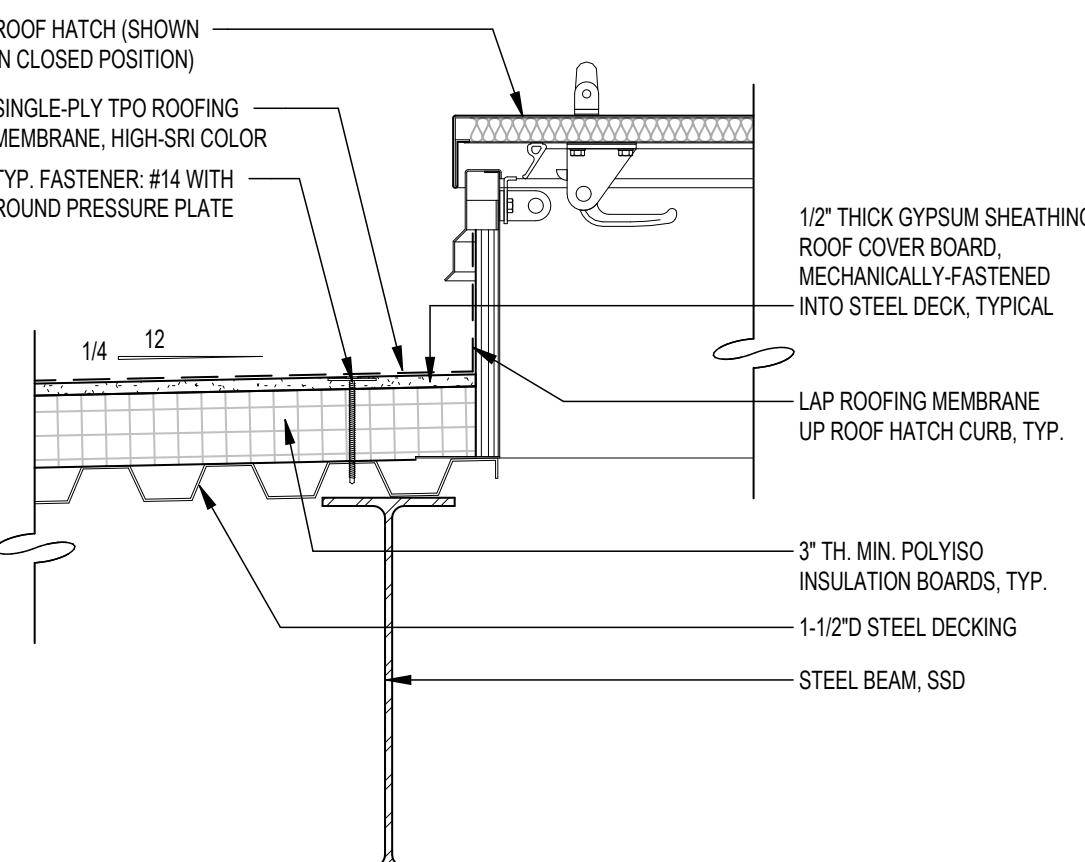


11 ROOF HATCH - CURB DETAIL
1 1/2" = 1'-0"

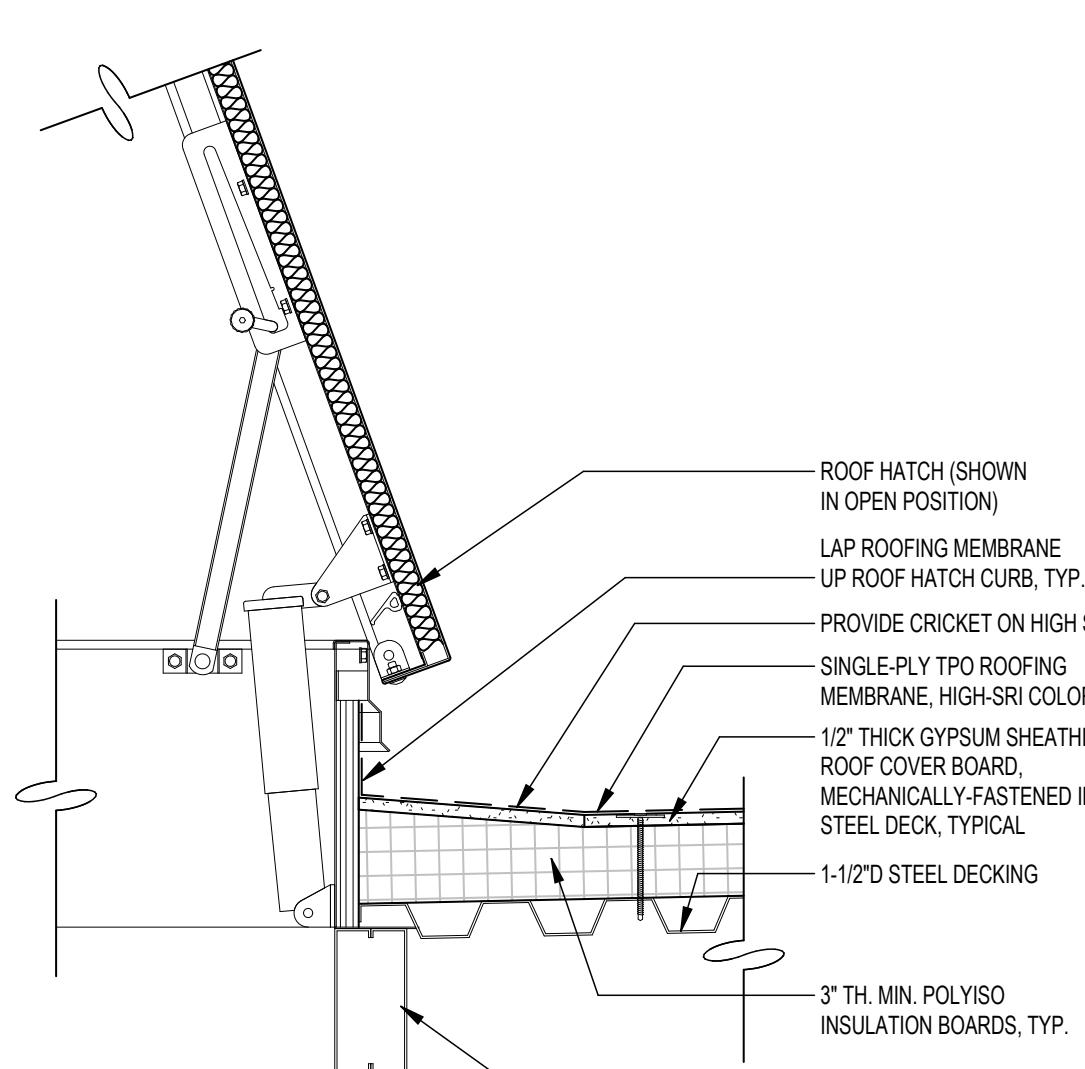


7 ROOF HATCH - CURB DETAIL (HIGH SIDE)
1 1/2" = 1'-0"

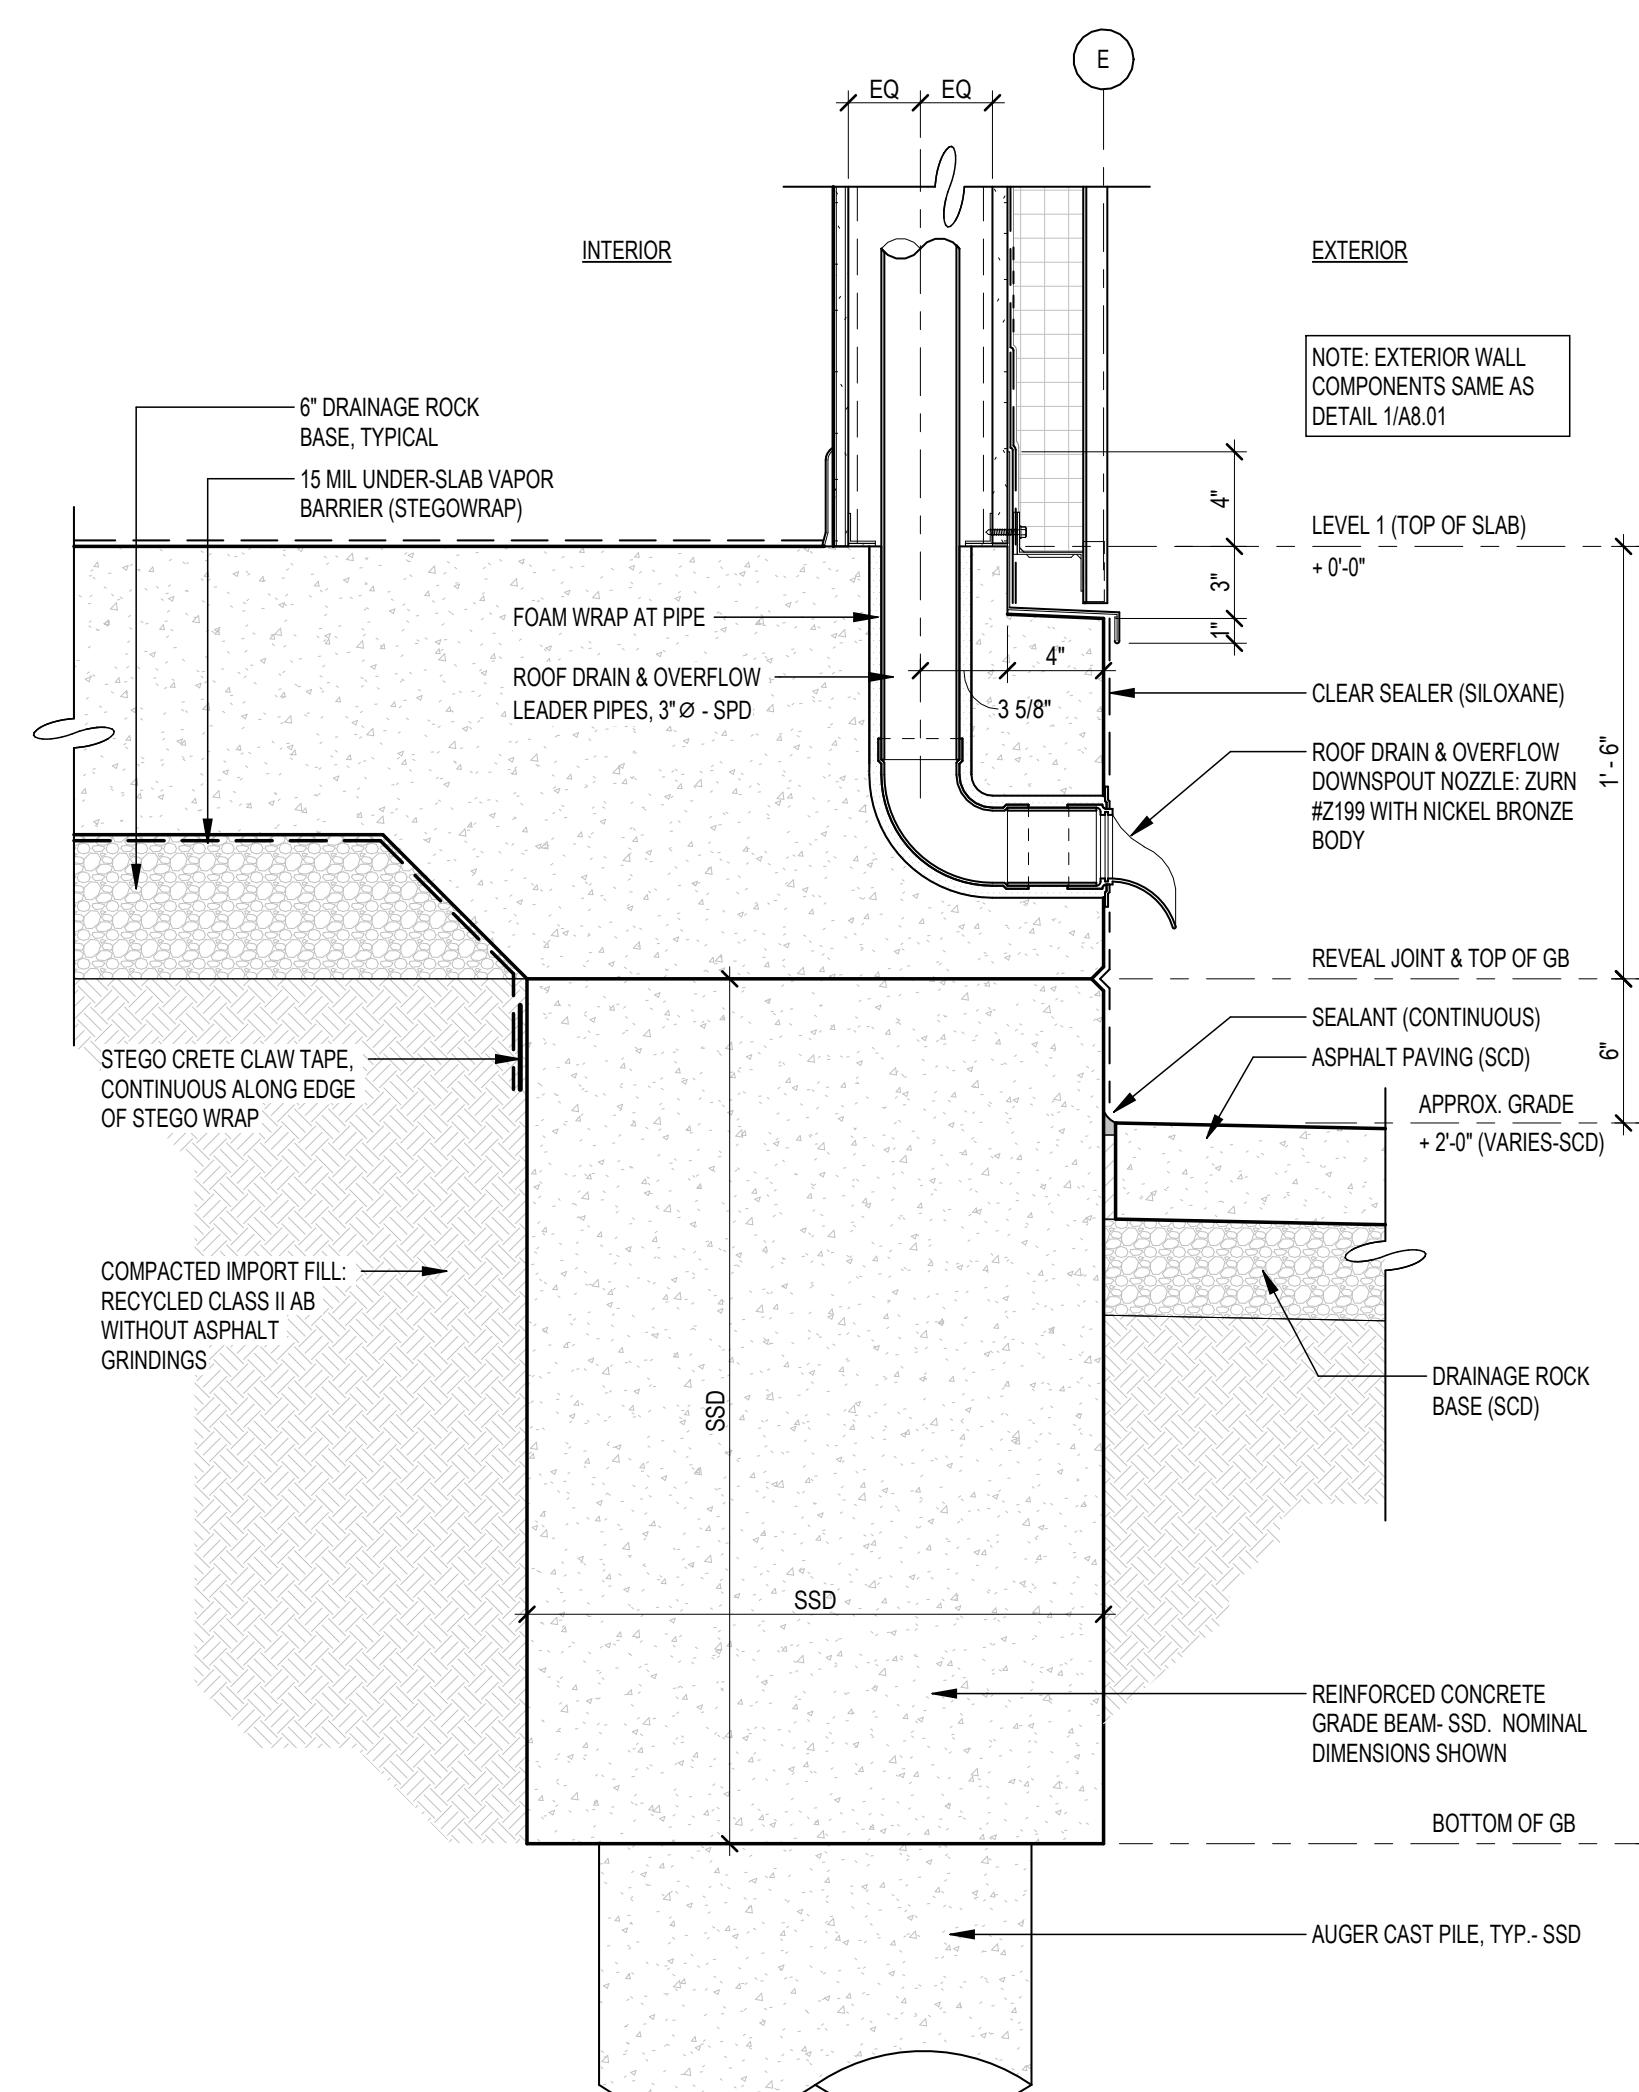

2 DETAIL-ROOF DRAIN & OF OUTLET @ GB - NORTH PAIR
1 1/2" = 1'-0"

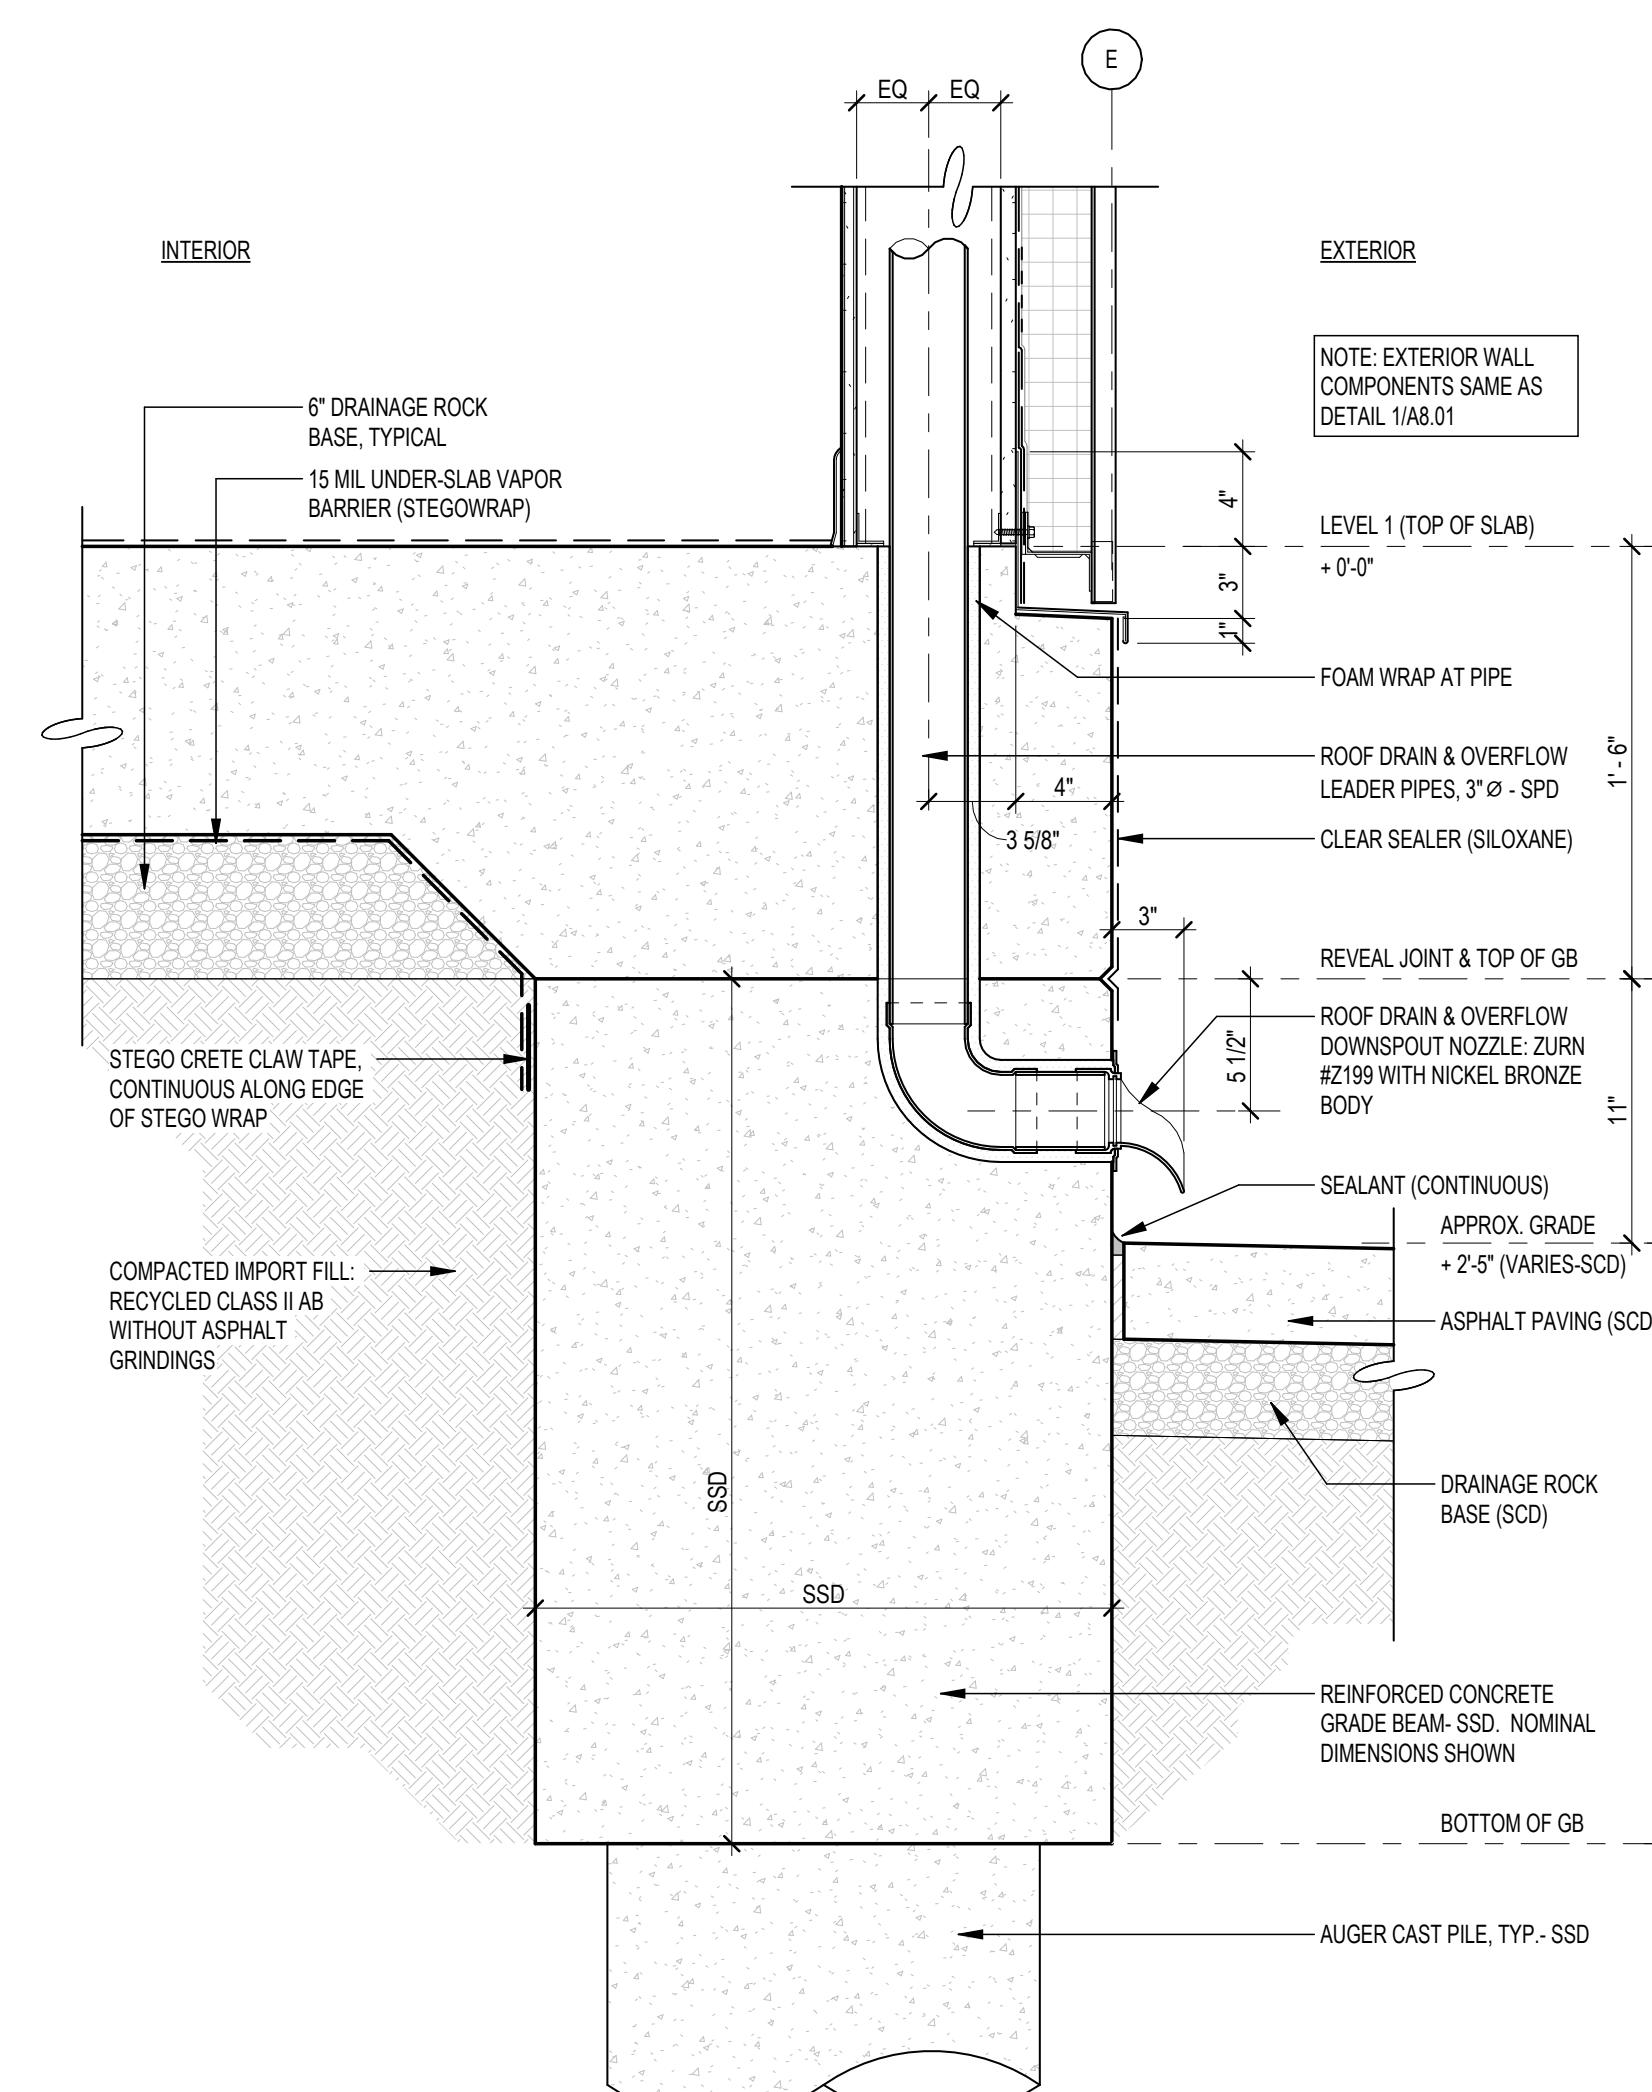

1 DETAIL-ROOF DRAIN & OF OUTLET @ GB - SOUTH PAIR
1 1/2" = 1'-0"

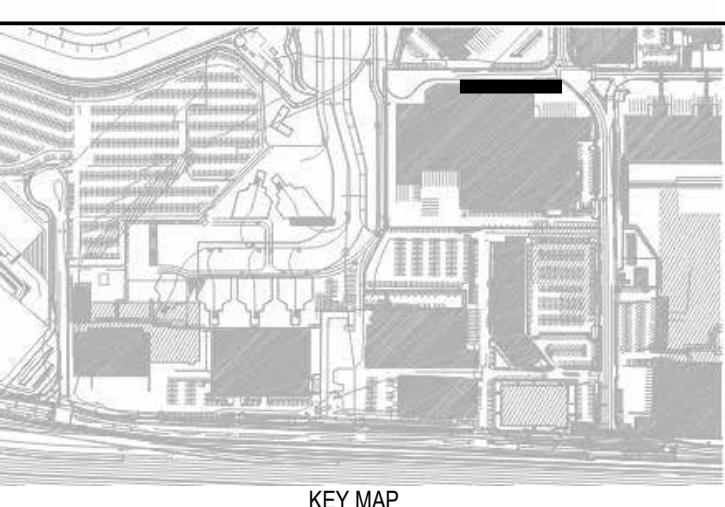


KEY MAP


REVISIONS	DESCRIPTION
NO DATE	BY

CONTRACT NO.	PROJECT TITLE
11921.66	WEST FIELD UTILITIES AND PAVING - STATION BP
SEAL	CONSULTANT'S LOGO
	PTA


DESIGNED BY: Designer	CHECKED BY: Checker
DRAWN BY: Author	DATE: 01/26/2026
SCALE: AS NOTED	SIZE: ARCH-D
SHEET NUMBER	
A8.0.6	
REVISION	OF

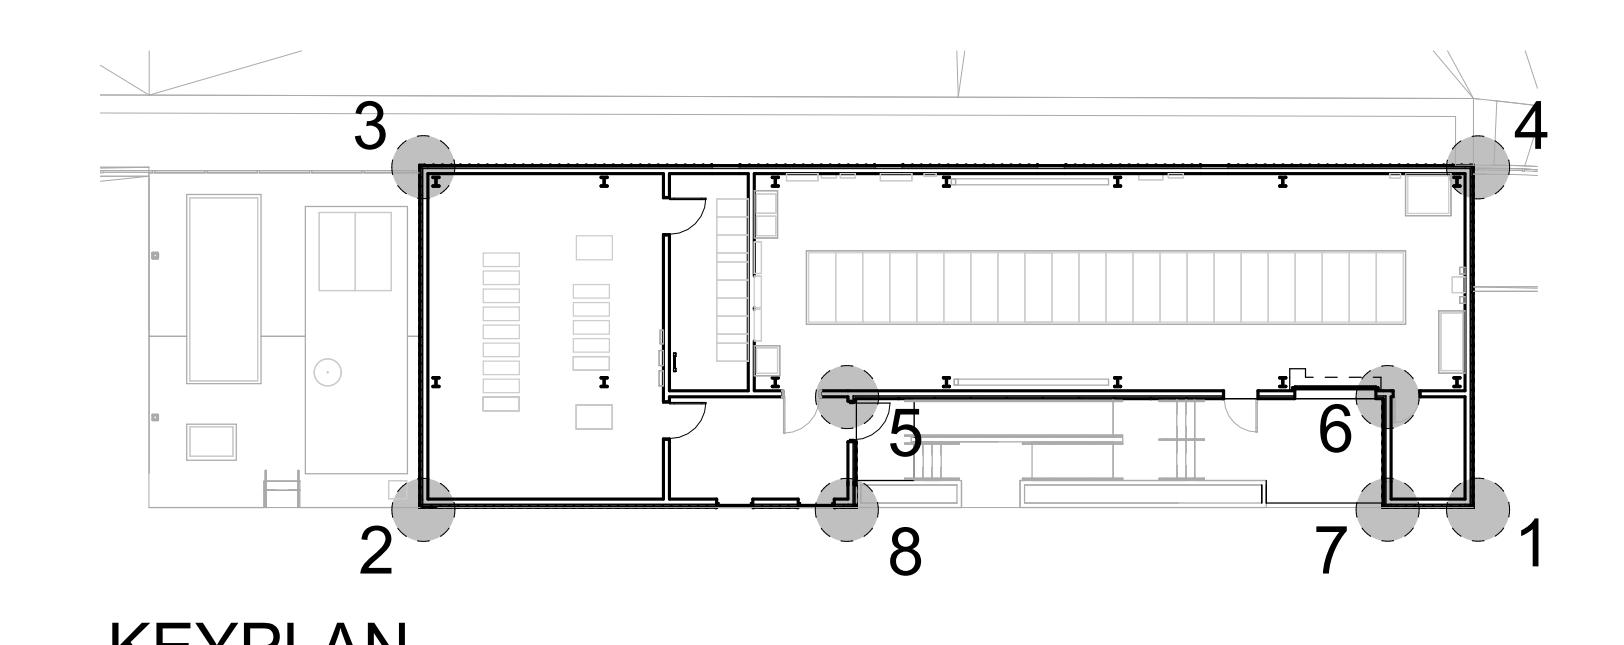


KEYPLAN

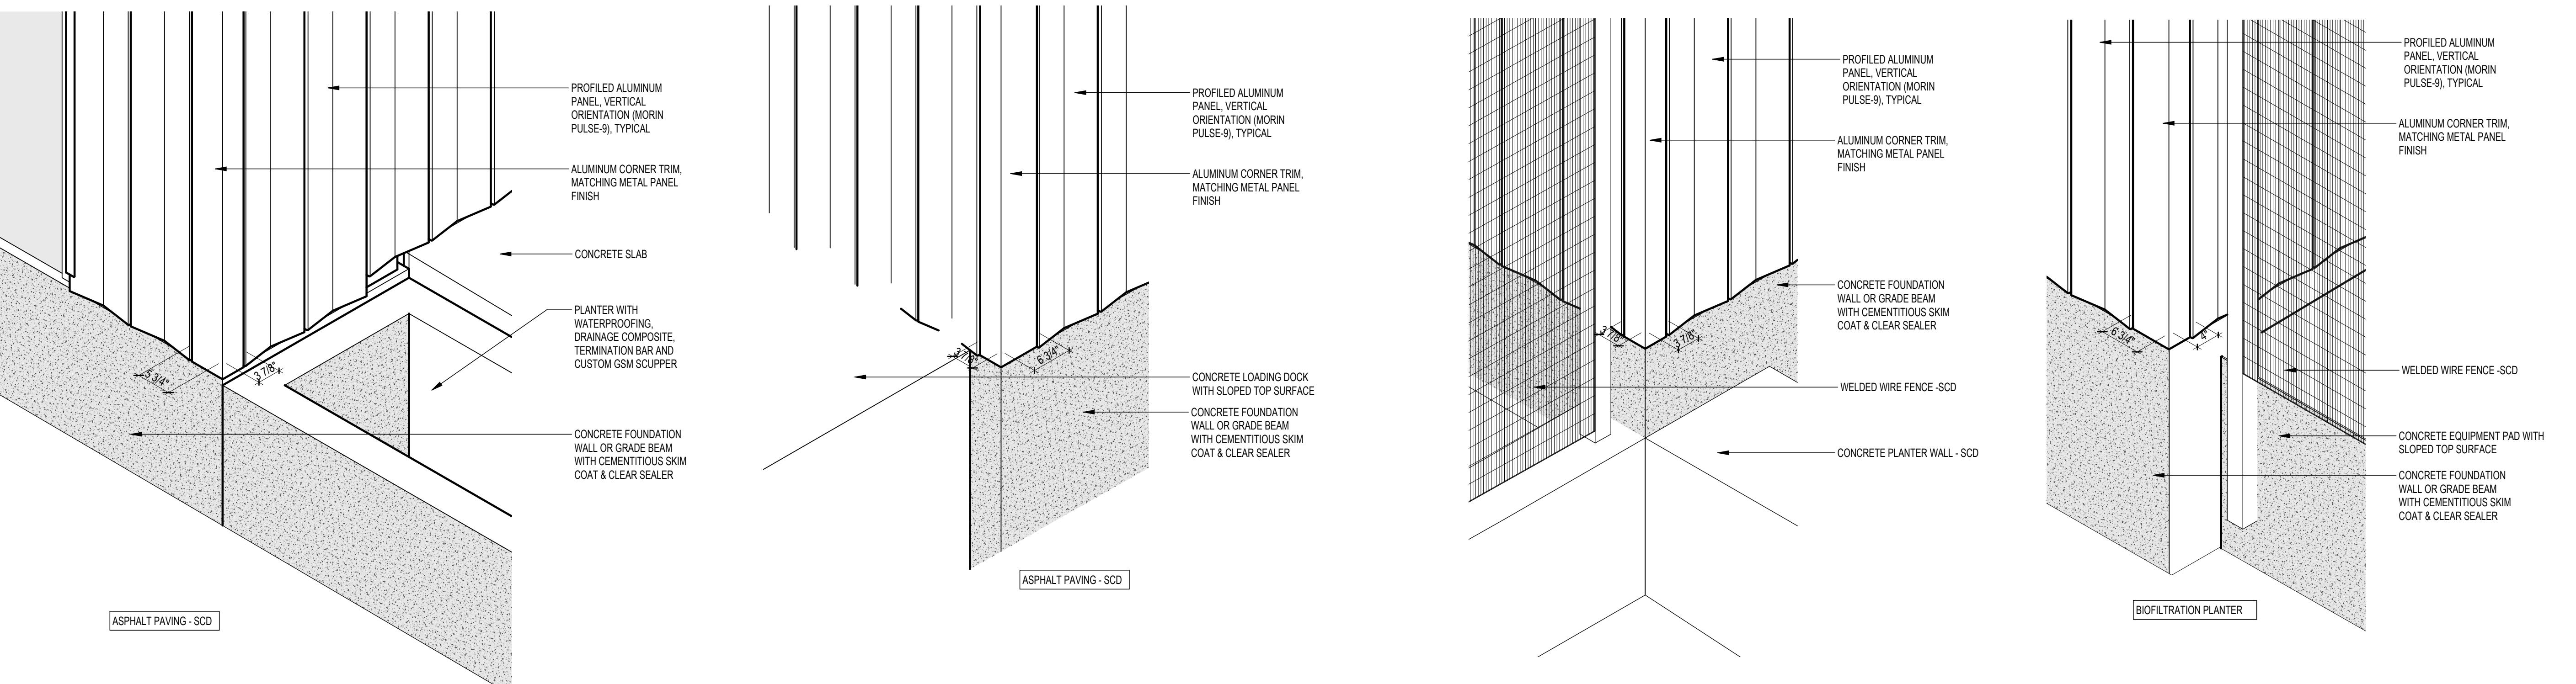

8 ISOMETRIC CORNER VIEW - ENTRY PORCH NORTH WEST (REF: 8/A.02)
7 ISOMETRIC CORNER VIEW - ENTRY PORCH SOUTH WEST (REF: 1/A.03)
4 ISOMETRIC CORNER VIEW - BUILDING SOUTH EAST (REF: 3/A.01)
3 ISOMETRIC CORNER VIEW - BUILDING NORTH EAST - EQUIPMENT PAD CORNER

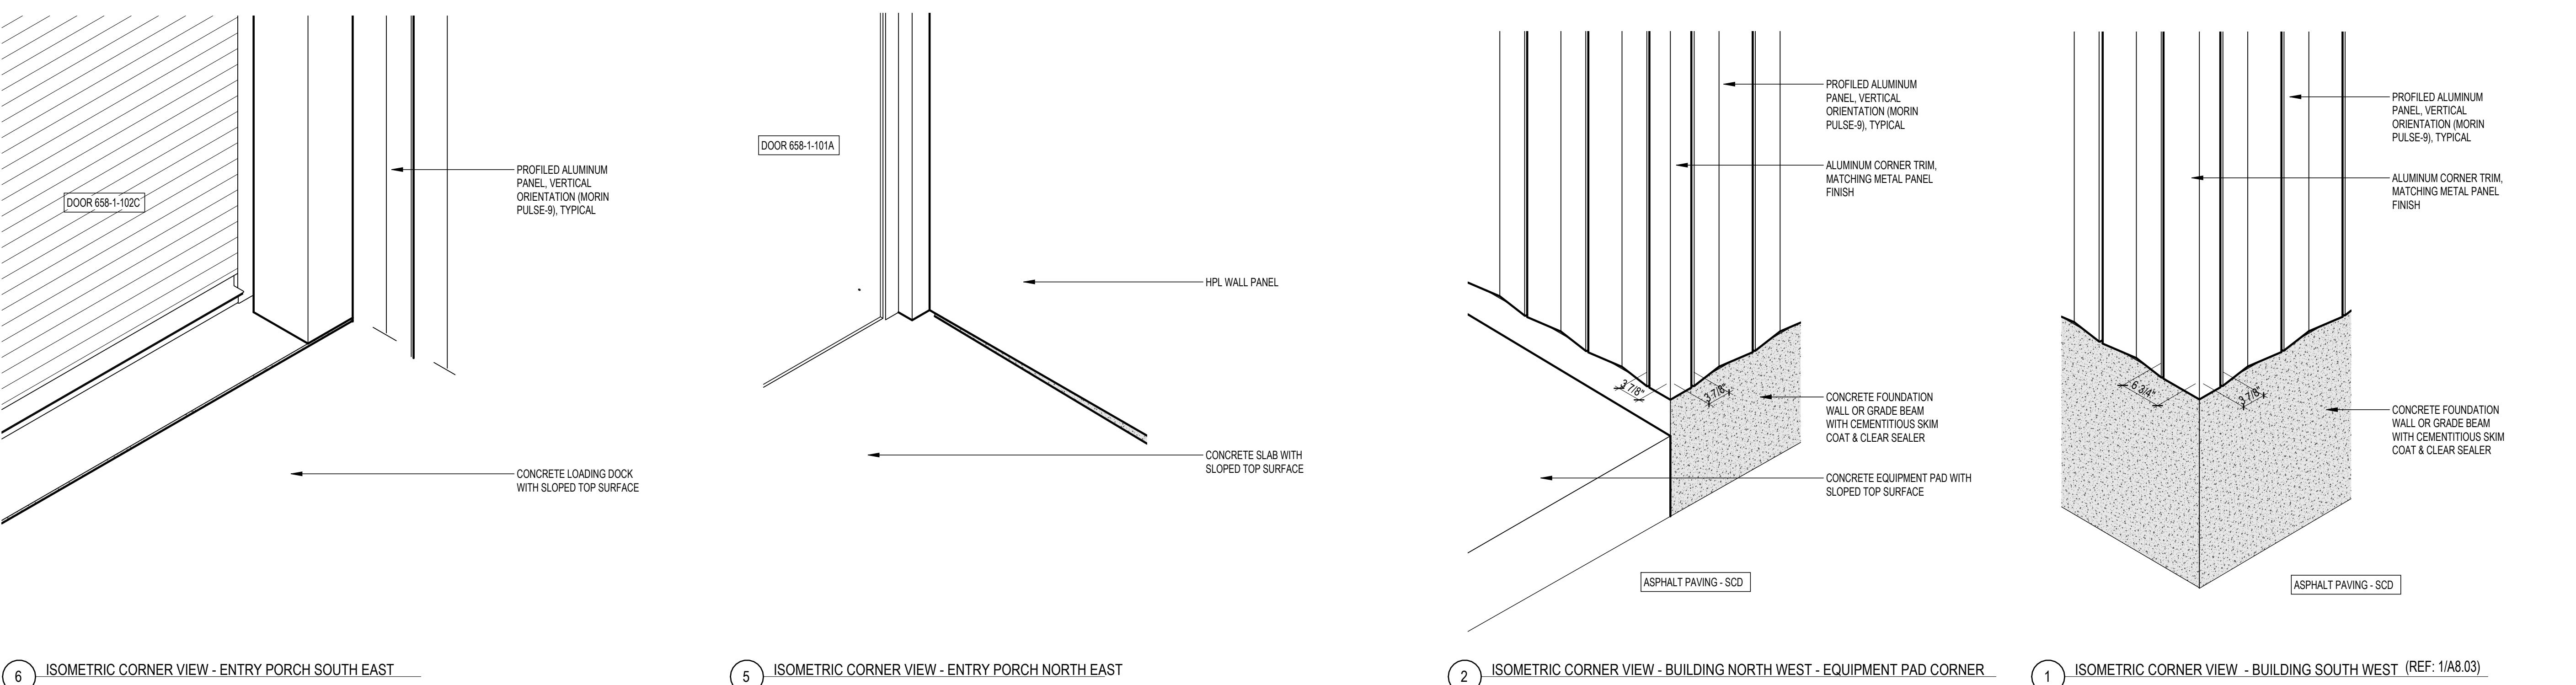


6 ISOMETRIC CORNER VIEW - ENTRY PORCH SOUTH EAST
5 ISOMETRIC CORNER VIEW - ENTRY PORCH NORTH EAST
2 ISOMETRIC CORNER VIEW - BUILDING NORTH WEST - EQUIPMENT PAD CORNER
1 ISOMETRIC CORNER VIEW - BUILDING SOUTH WEST (REF: 1/A.03)

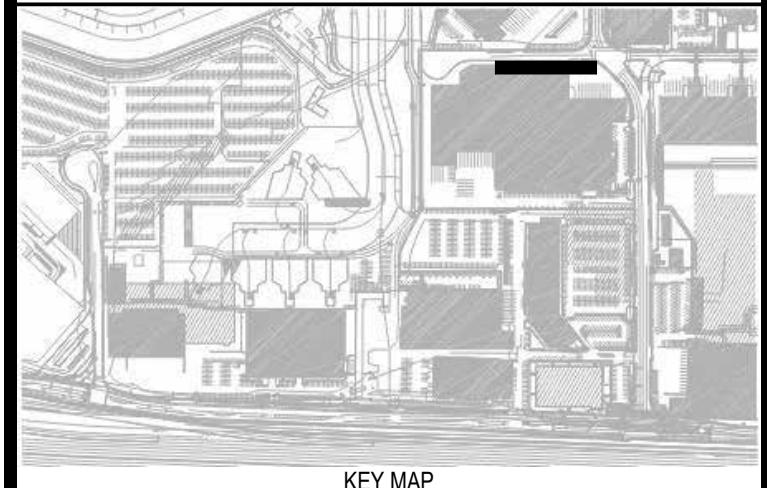


DOOR SCHEDULE					
Door Number	Family	Type	Hardware Group	Electrified Opening	INCLUDE IN SCHEDULE
58-1-E104	A1 - Single Flush Door	48" x 84"	04	Electrified Opening	Y
58-1-E105	A1 - Single Flush Door	48" x 84"	05	Electrified Opening	Y
58-1-E102A	A1 - Single Flush Door	48" x 84"	02	Electrified Opening	Y
58-1-E102B	A1 - Single Flush Door	44" x 106"	01	Electrified Opening	Y
58-1-M103	A1 - Single Flush Door	34" x 84"	03		Y
58-1-101	Door-Curtain-Wall-Single-Glass	Door-Curtain-Wall-Single-Glass	01	Electrified Opening	Y
58-1-E102C	Door_Service_FaceOfWallMount_k	Motor Operated, Aluminium (Mill Finish)	06		Y

WINDOW & LOUVER SCHEDULE


NUMBER	WIDTH	HEIGHT
OUVER		
1	4' - 0"	2' - 7"
2	4' - 0"	2' - 7"
3	4' - 0"	2' - 7"
4	3' - 0"	7' - 2"
5	3' - 0"	7' - 2"
6	2' - 10 1/2"	7' - 2"
7	3' - 2 1/8"	7' - 2"
8	2' - 0"	3' - 0"
9	4' - 6 5/8"	7' - 8"
WINDOW		
/1	4' - 0"	20' -11"
/2	4' - 0"	20' -11"

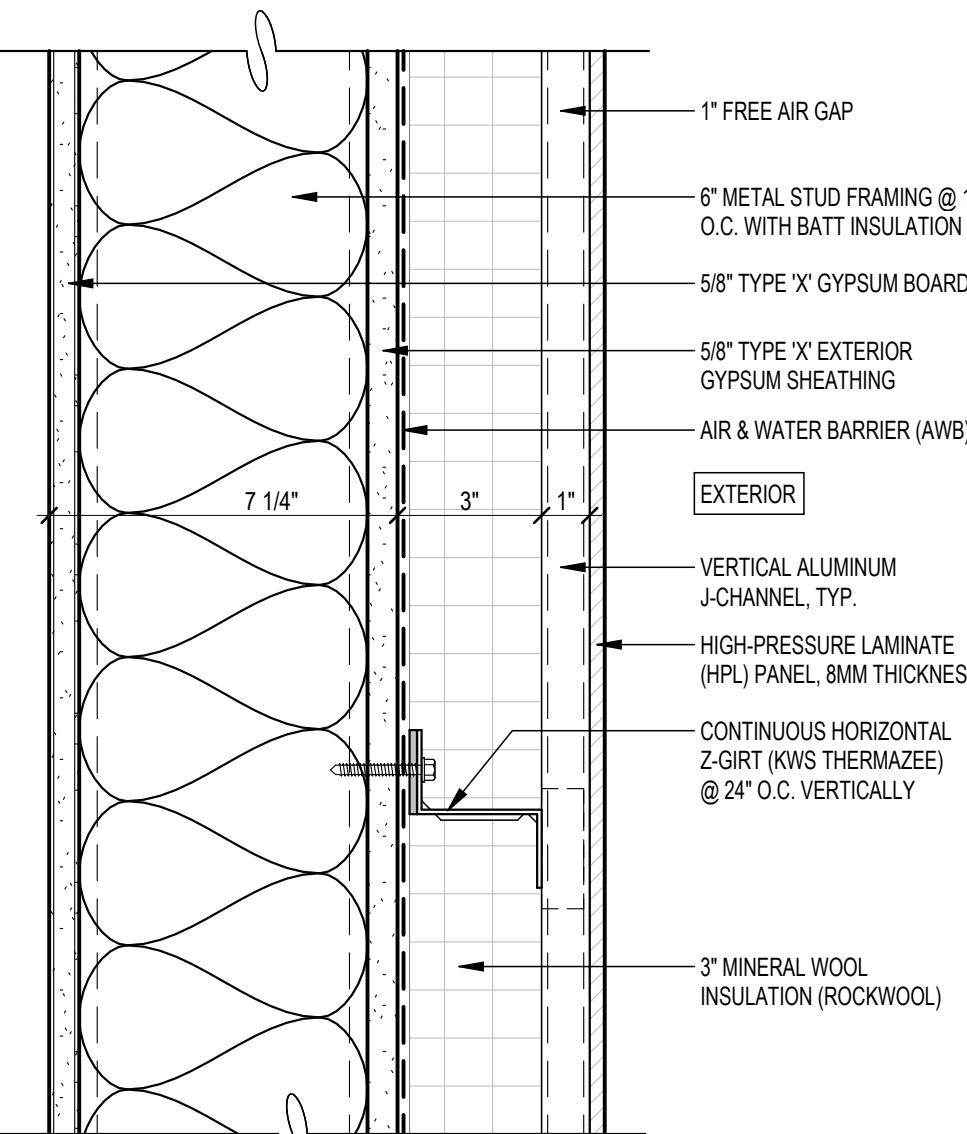


EXTERIOR PARTITION- HPL PANELS

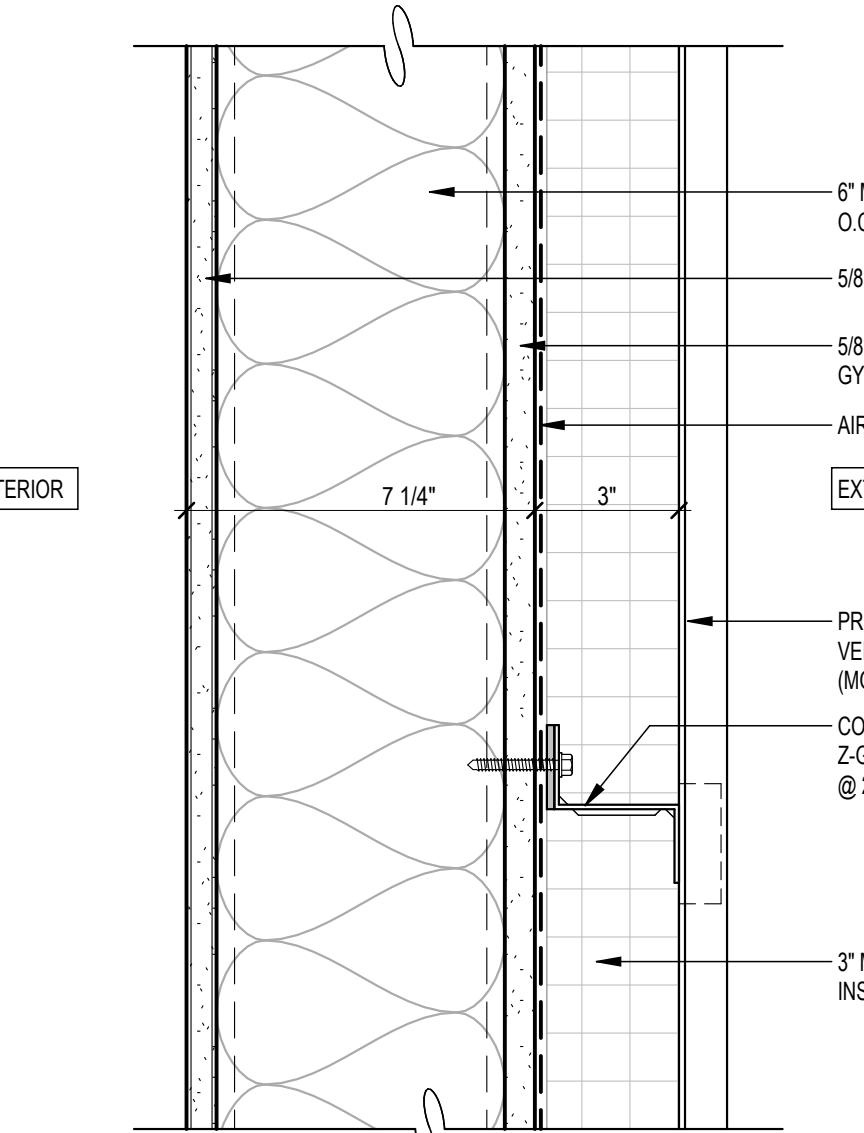



WE1 EXTERIOR PARTITION- METAL PANELS
3" = 1'-0"

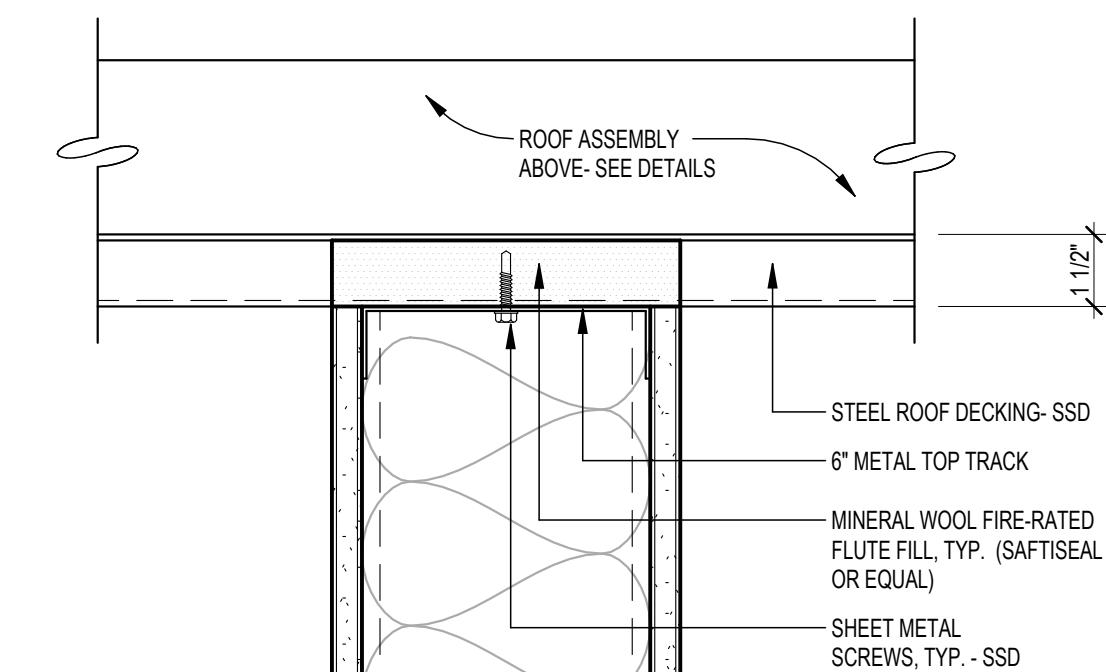

A technical diagram of a door frame. The frame is made of dark wood and is set into a white wall. The width of the opening is labeled as 7 1/4". A vertical reference line is drawn through the center of the frame, intersecting the door panels. The door panels are slightly curved. The overall width of the frame is indicated by two vertical lines on the wall.

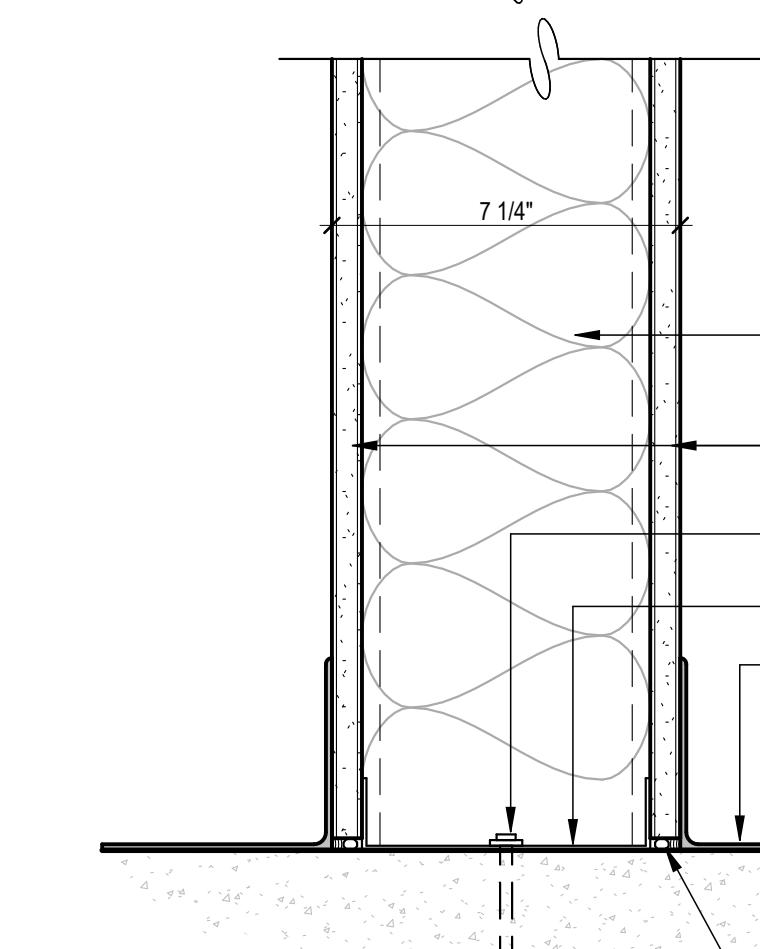

W1 INTERIOR PARTITION- 1HR FIRE-RATED
3" = 1'-0"

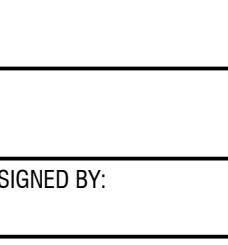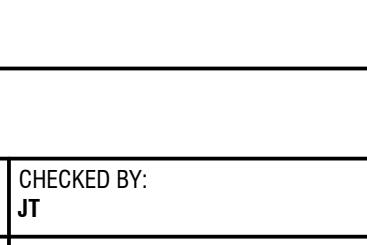CONTRACT NO.		11921.66		REVISIONS	
PROJECT TITLE		WEST FIELD UTILITIES AND PAVING - STATION BP		DESCRIPTION	
NO	DATE				
SHEET TITLE		PARTITION TYPES, DOOR & WINDOW SCHEDULES			
SEAL		CONSULTANT'S LOGO			
					
DESIGNED BY: JT		CHECKED BY: JT			
DRAWN BY: JT		DATE: 01/26/2026			
SCALE: AS NOTED		SIZE: ARCH-D			
SHEET NUMBER A9.0.1					
REVISION _____ OF _____					